



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	INDEX						
SHEET NO.	DRAWING INDEX						
1	Title Sheet						
2	Index and General Notes						
3	Plan Index Location Maps						
4	Witnesses and Benchmarks						
5	Geometric Tie-Up Details						
6-8	Maintenance of Traffic Details						
9	Intersection Details - Main Street						
10-11	Intersection Details - Michigan Street						
12	Spot Elevation Details - Main Street						
13	Spot Elevation Details - Michigan Street						
14	Traffic Signal Detail - Main Street						
15-16	Traffic Signal Details - Michigan Street						
17-21	Pavement Marking & Signing Plans - Main Street						
22 - 26	Pavement Marking & Signing Plans - Michigan Street						
27	Erosion Control Table						

	HORIZONTAL SCALE	BRIDGE FILE		
CITY OF SOUTH BEND	N/A	N/A		
	VERTICAL SCALE	DESIGNATION		
	N/A	N/A		
	SURVEY BOOK	SHEETS		
	SURVEY BOOK	SHEETS 2 of 27		
INDEX AND GENERAL NOTES				





No. * 10504741 *	RECOMMENDED FOR APPROVAL	Ank	DESIGN ENGINEER	1/15/2016 DATE	
10504741 * STATE OF WDIAN *	DESIGNED:	MRR	DRAWN:	MRR	
THE SCONAL ENGINE	CHECKED:	PKW	CHECKED:	PKW	

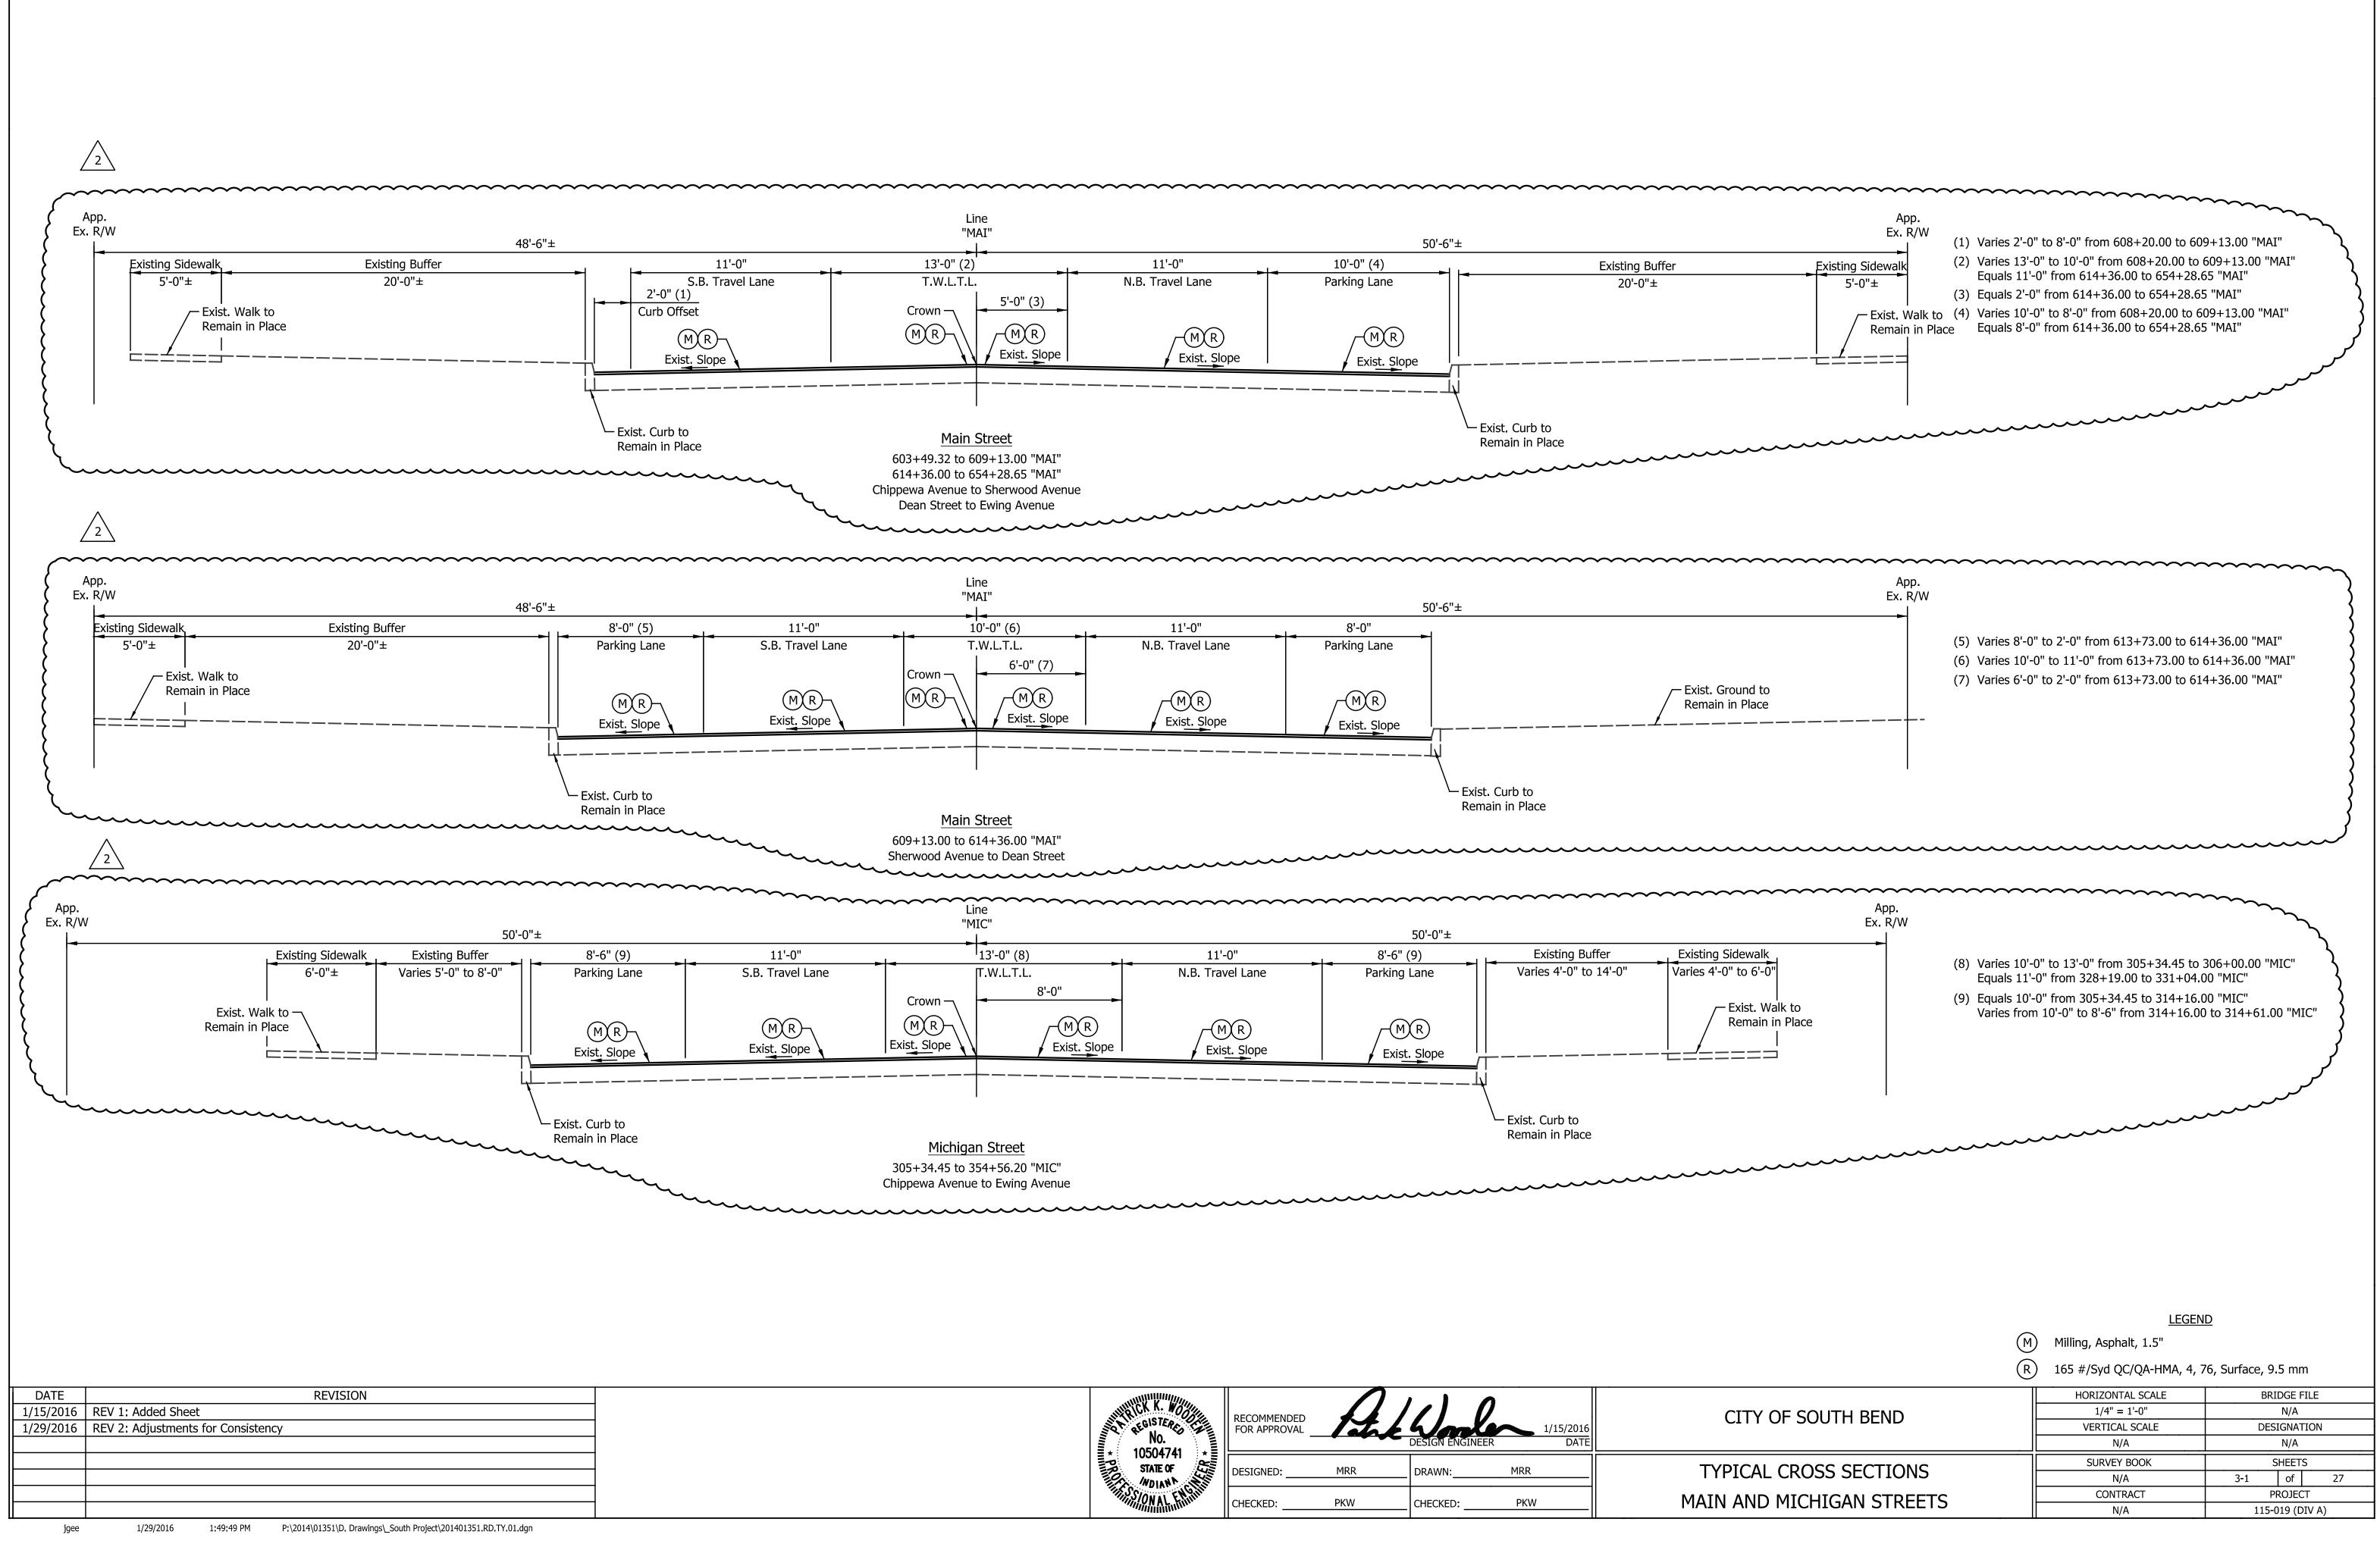

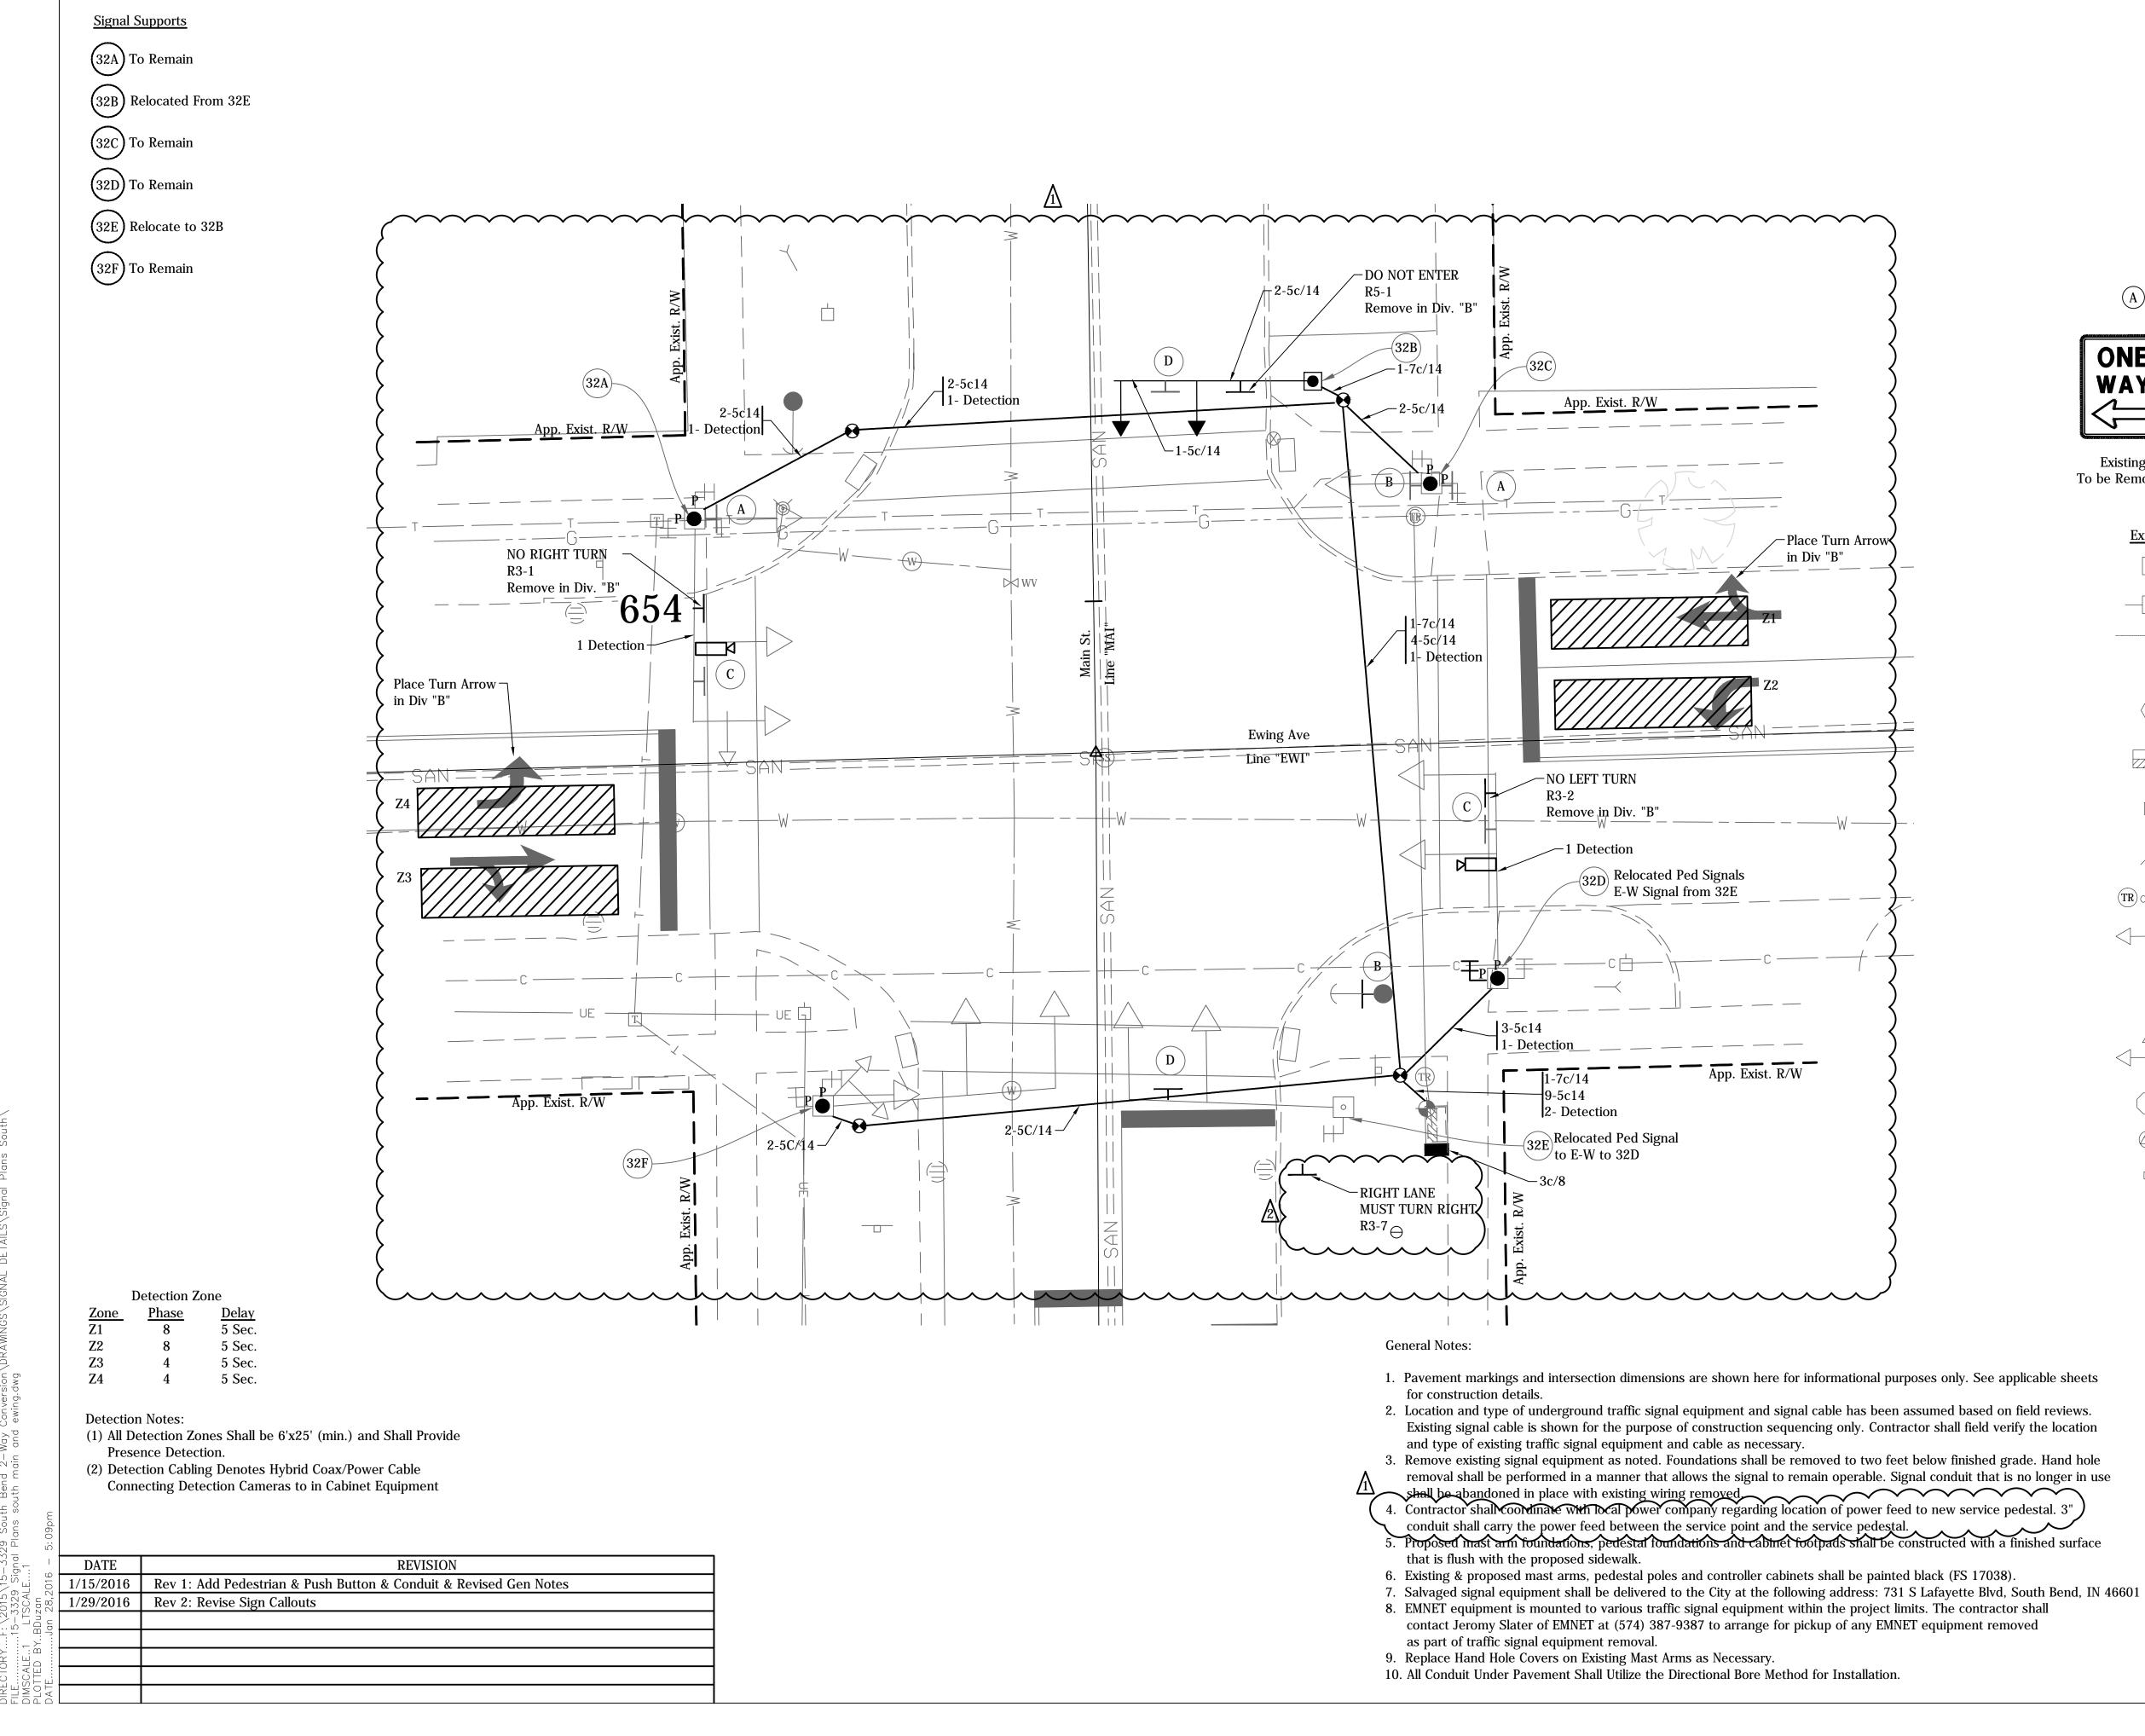- 1. Pavement markings and intersection dimensions are shown here for informational purposes only. See applicable sheets
- Existing signal cable is shown for the purpose of construction sequencing only. Contractor shall field verify the location
- removal shall be performed in a manner that allows the signal to remain operable. Signal conduit that is no longer in use


- 6. Existing & proposed mast arms, pedestal poles and controller cabinets shall be painted black (FS 17038).
- 8. EMNET equipment is mounted to various traffic signal equipment within the project limits. The contractor shall
- contact Jeromy Slater of EMNET at (574) 387-9387 to arrange for pickup of any EMNET equipment removed

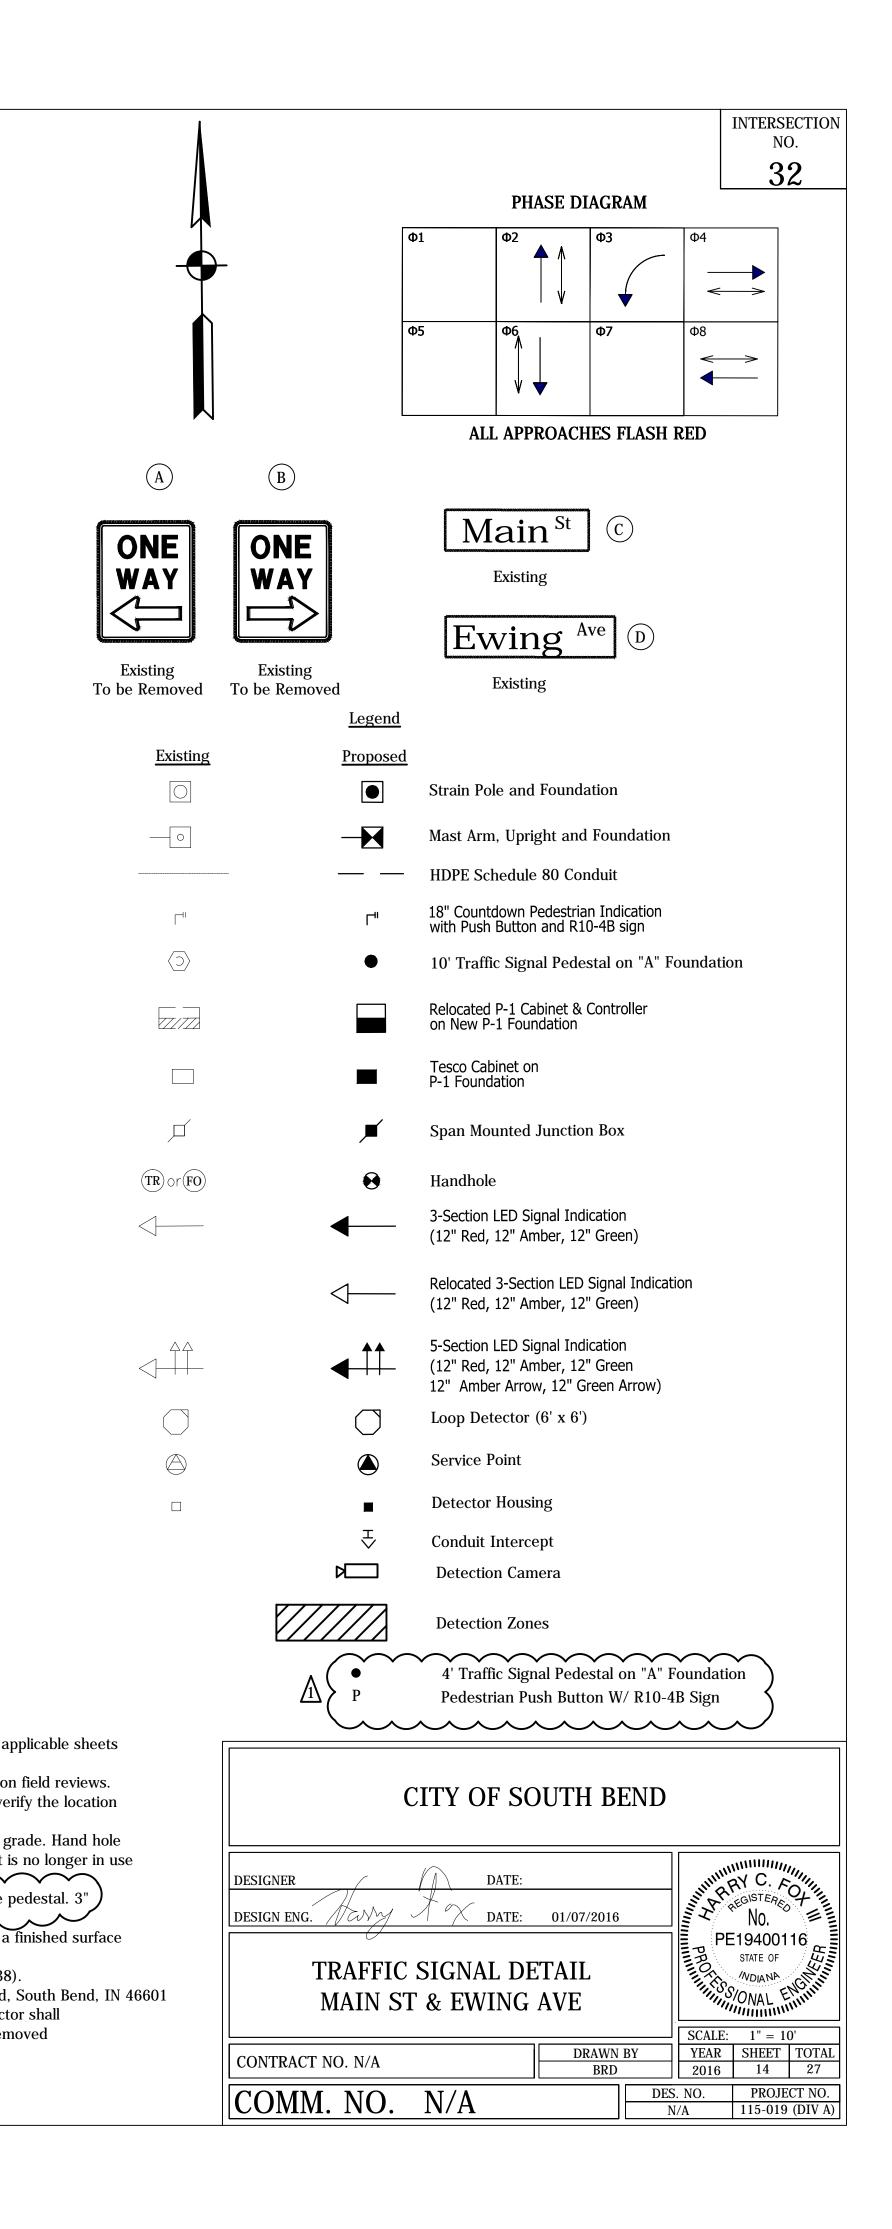


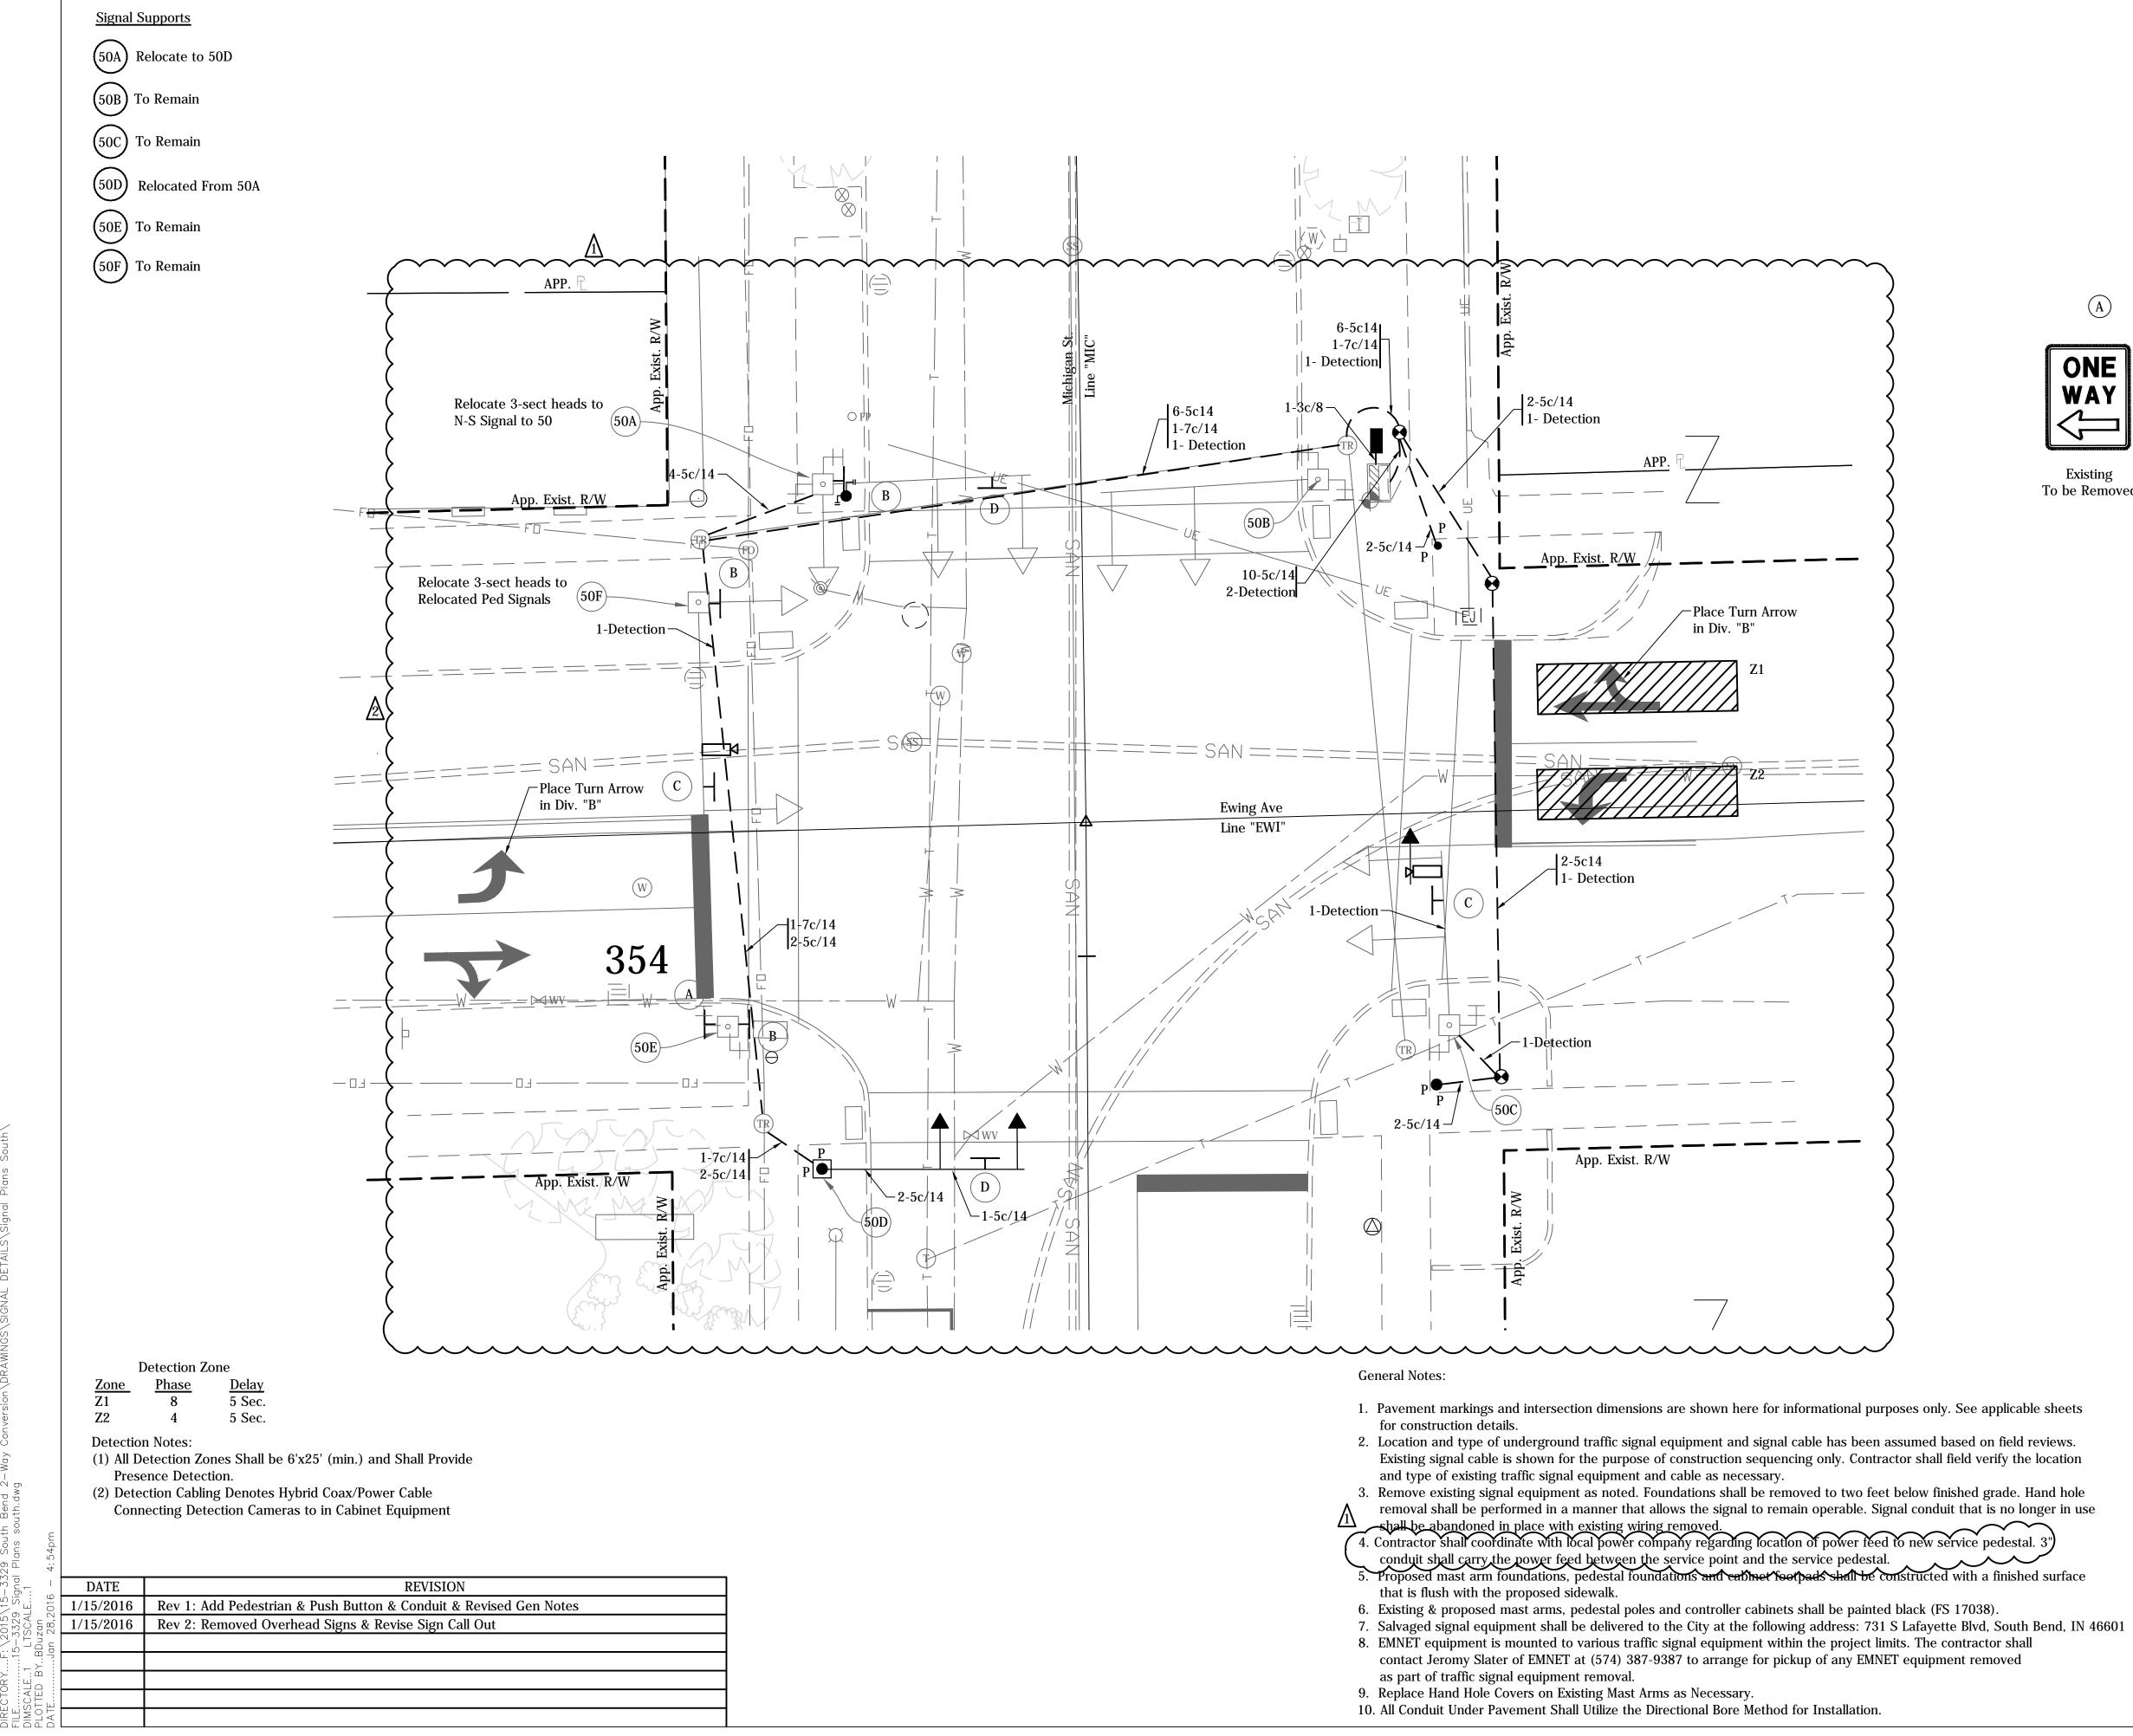


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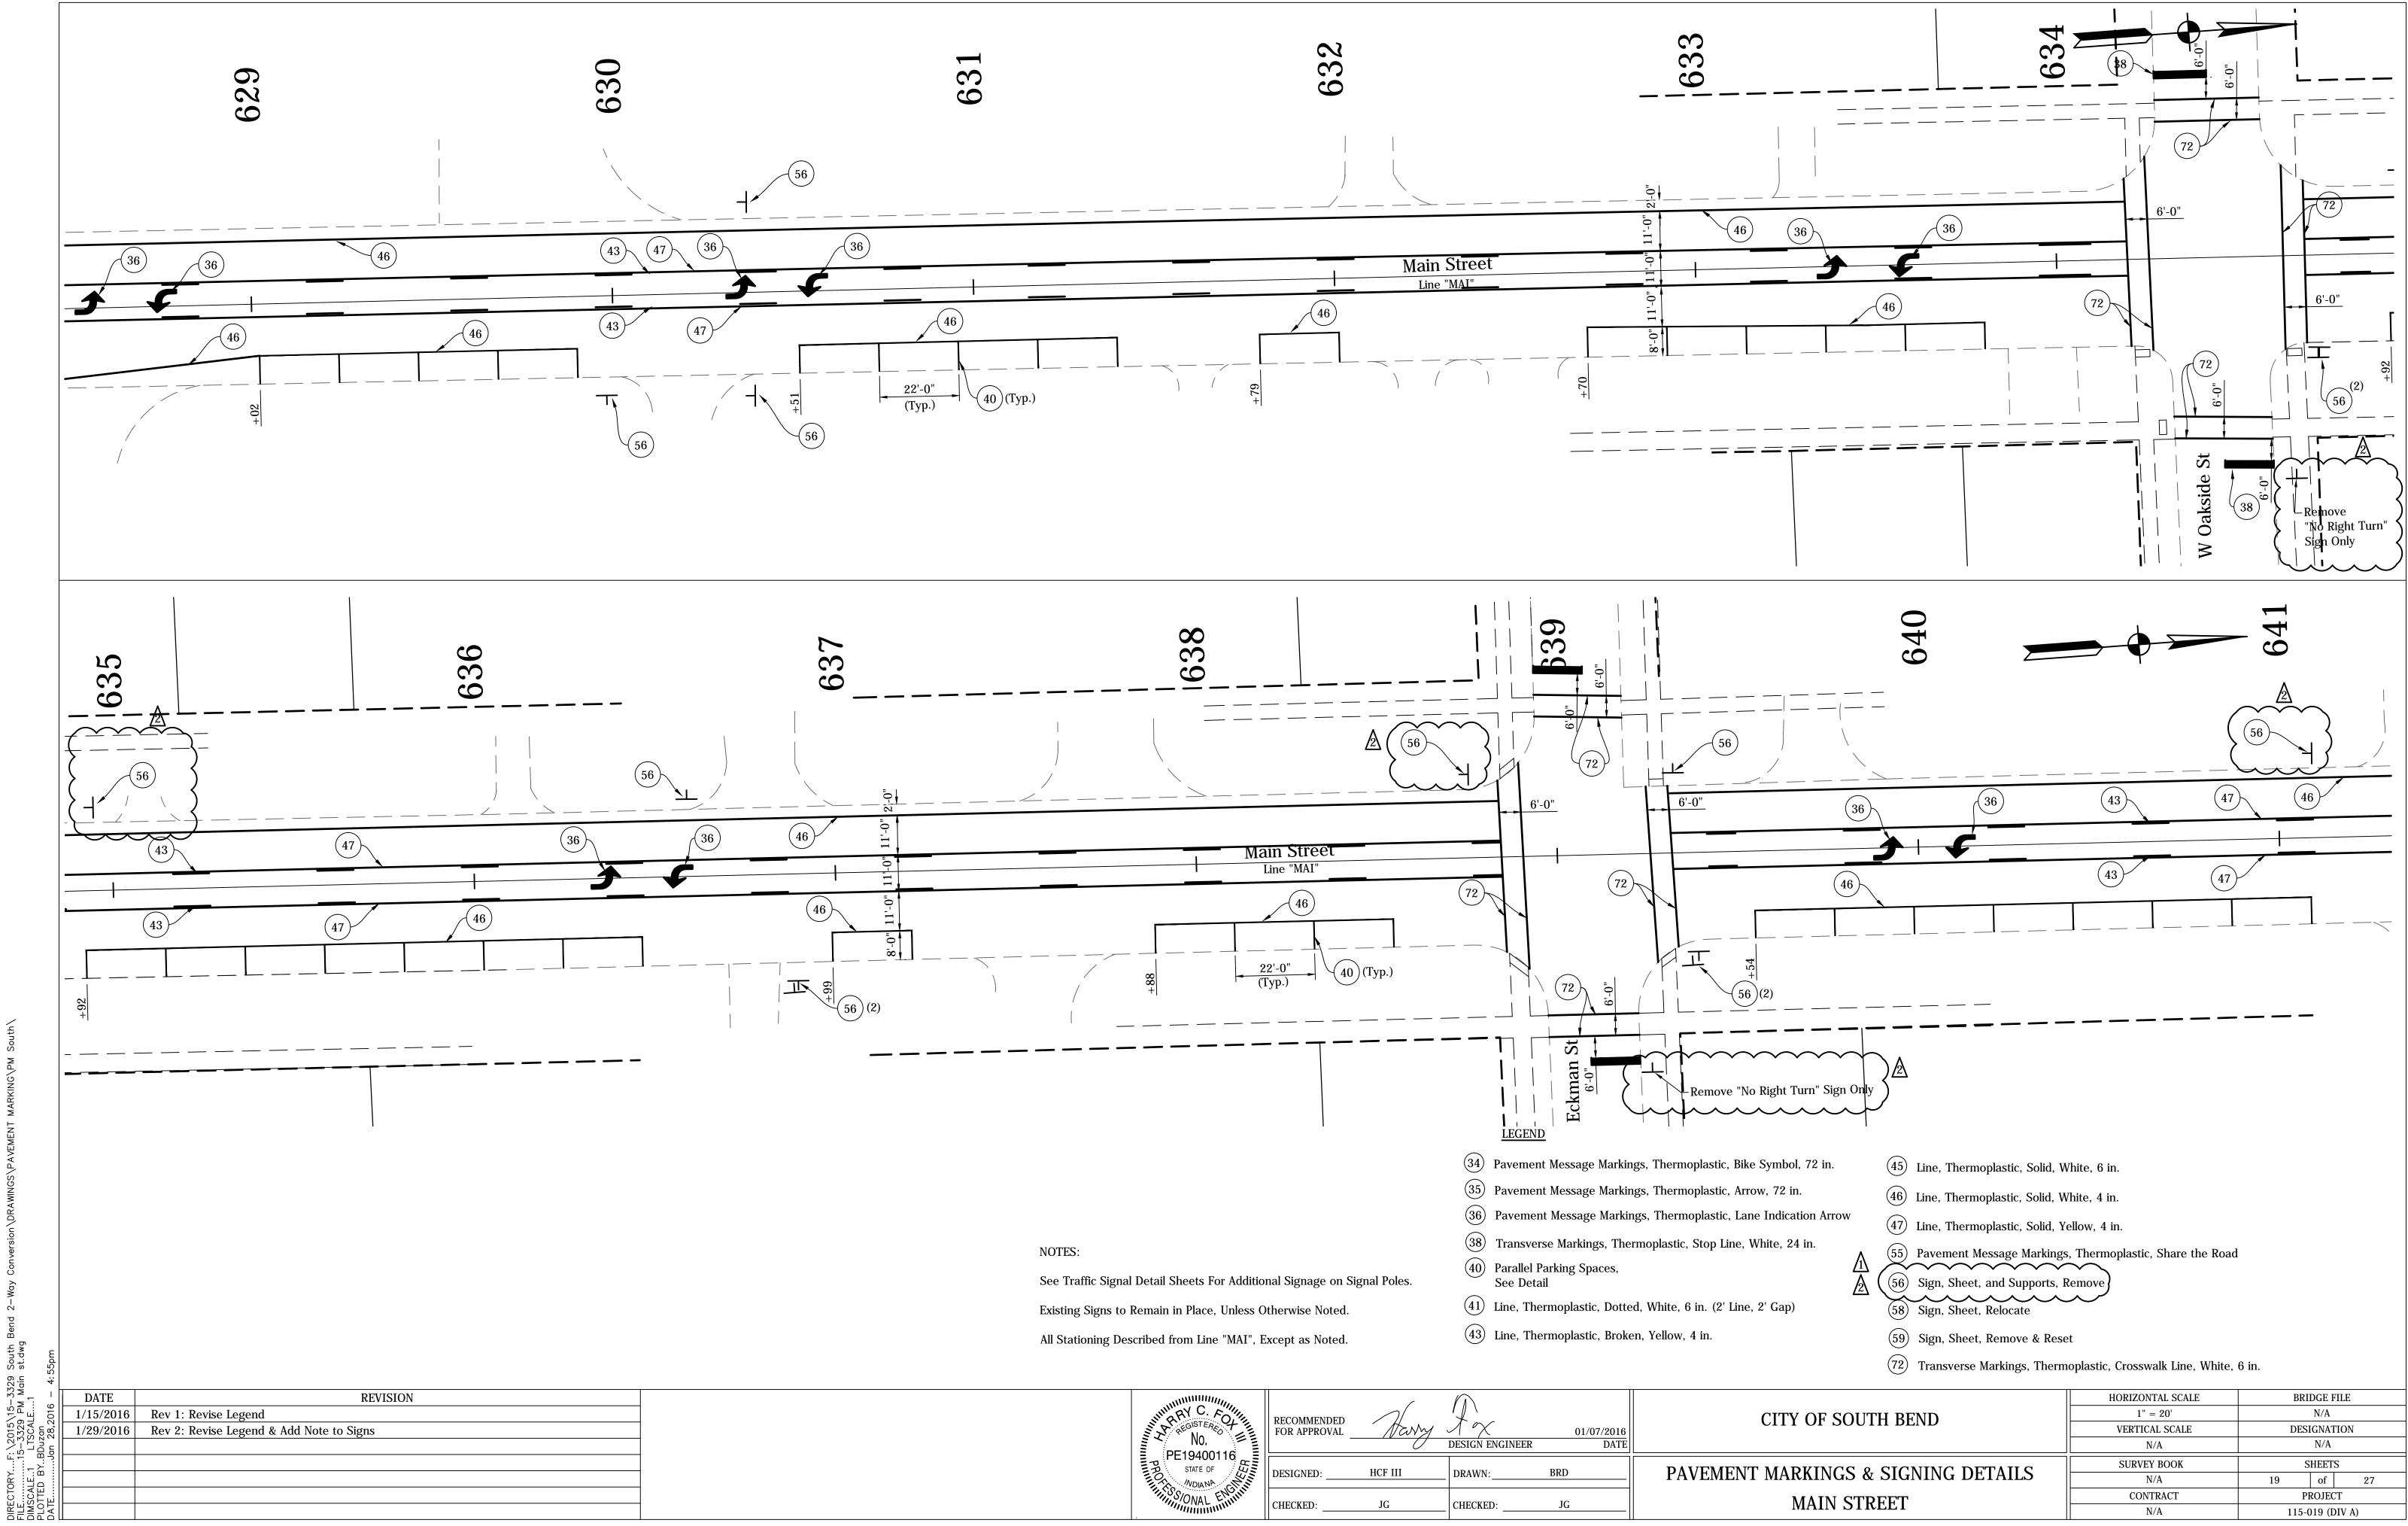


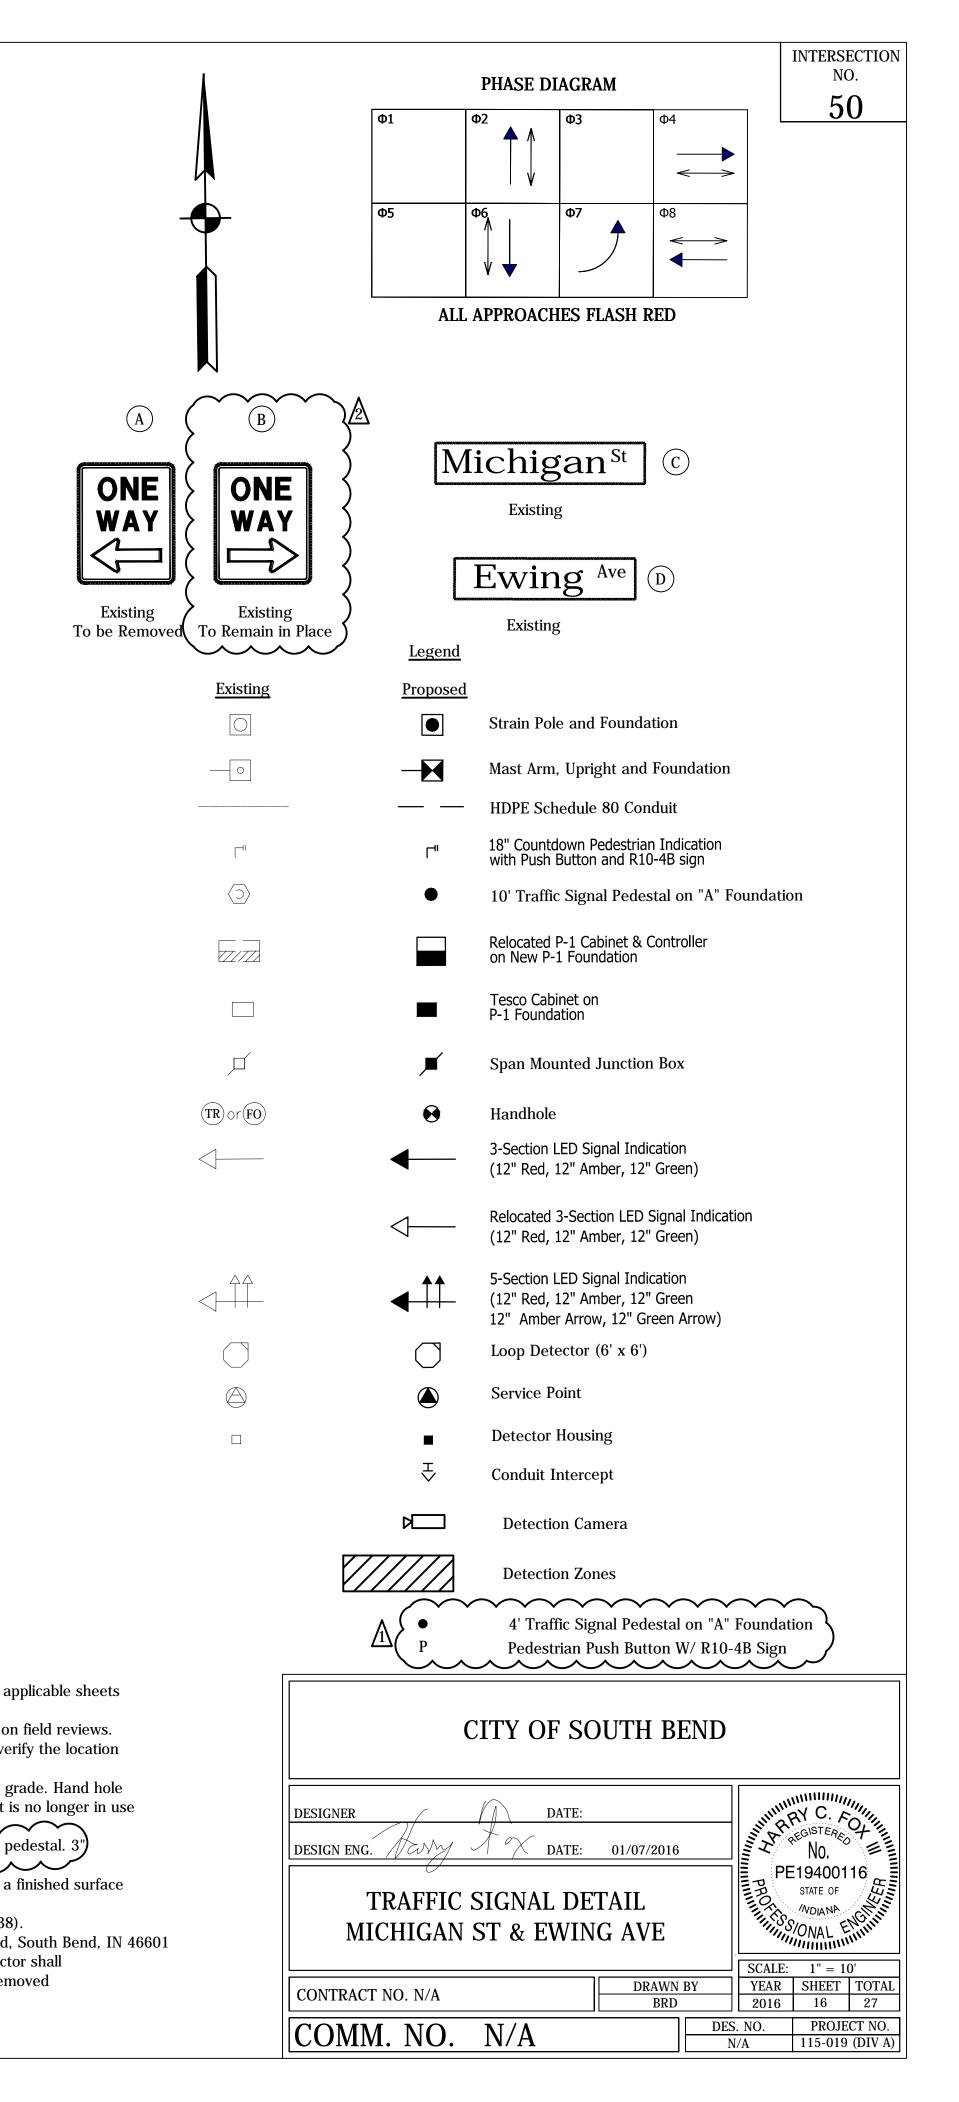


Willing PROTIN	NO. PE19400116	RECOMMENDED FOR APPROVAL	Harry	DESIGN ENGINEER	01/07/2016 DATE	
	PET9400110	DESIGNED:	HCF III JG	_ DRAWN: CHECKED:	BRD JG	PAVEM
			30		<u> </u>	

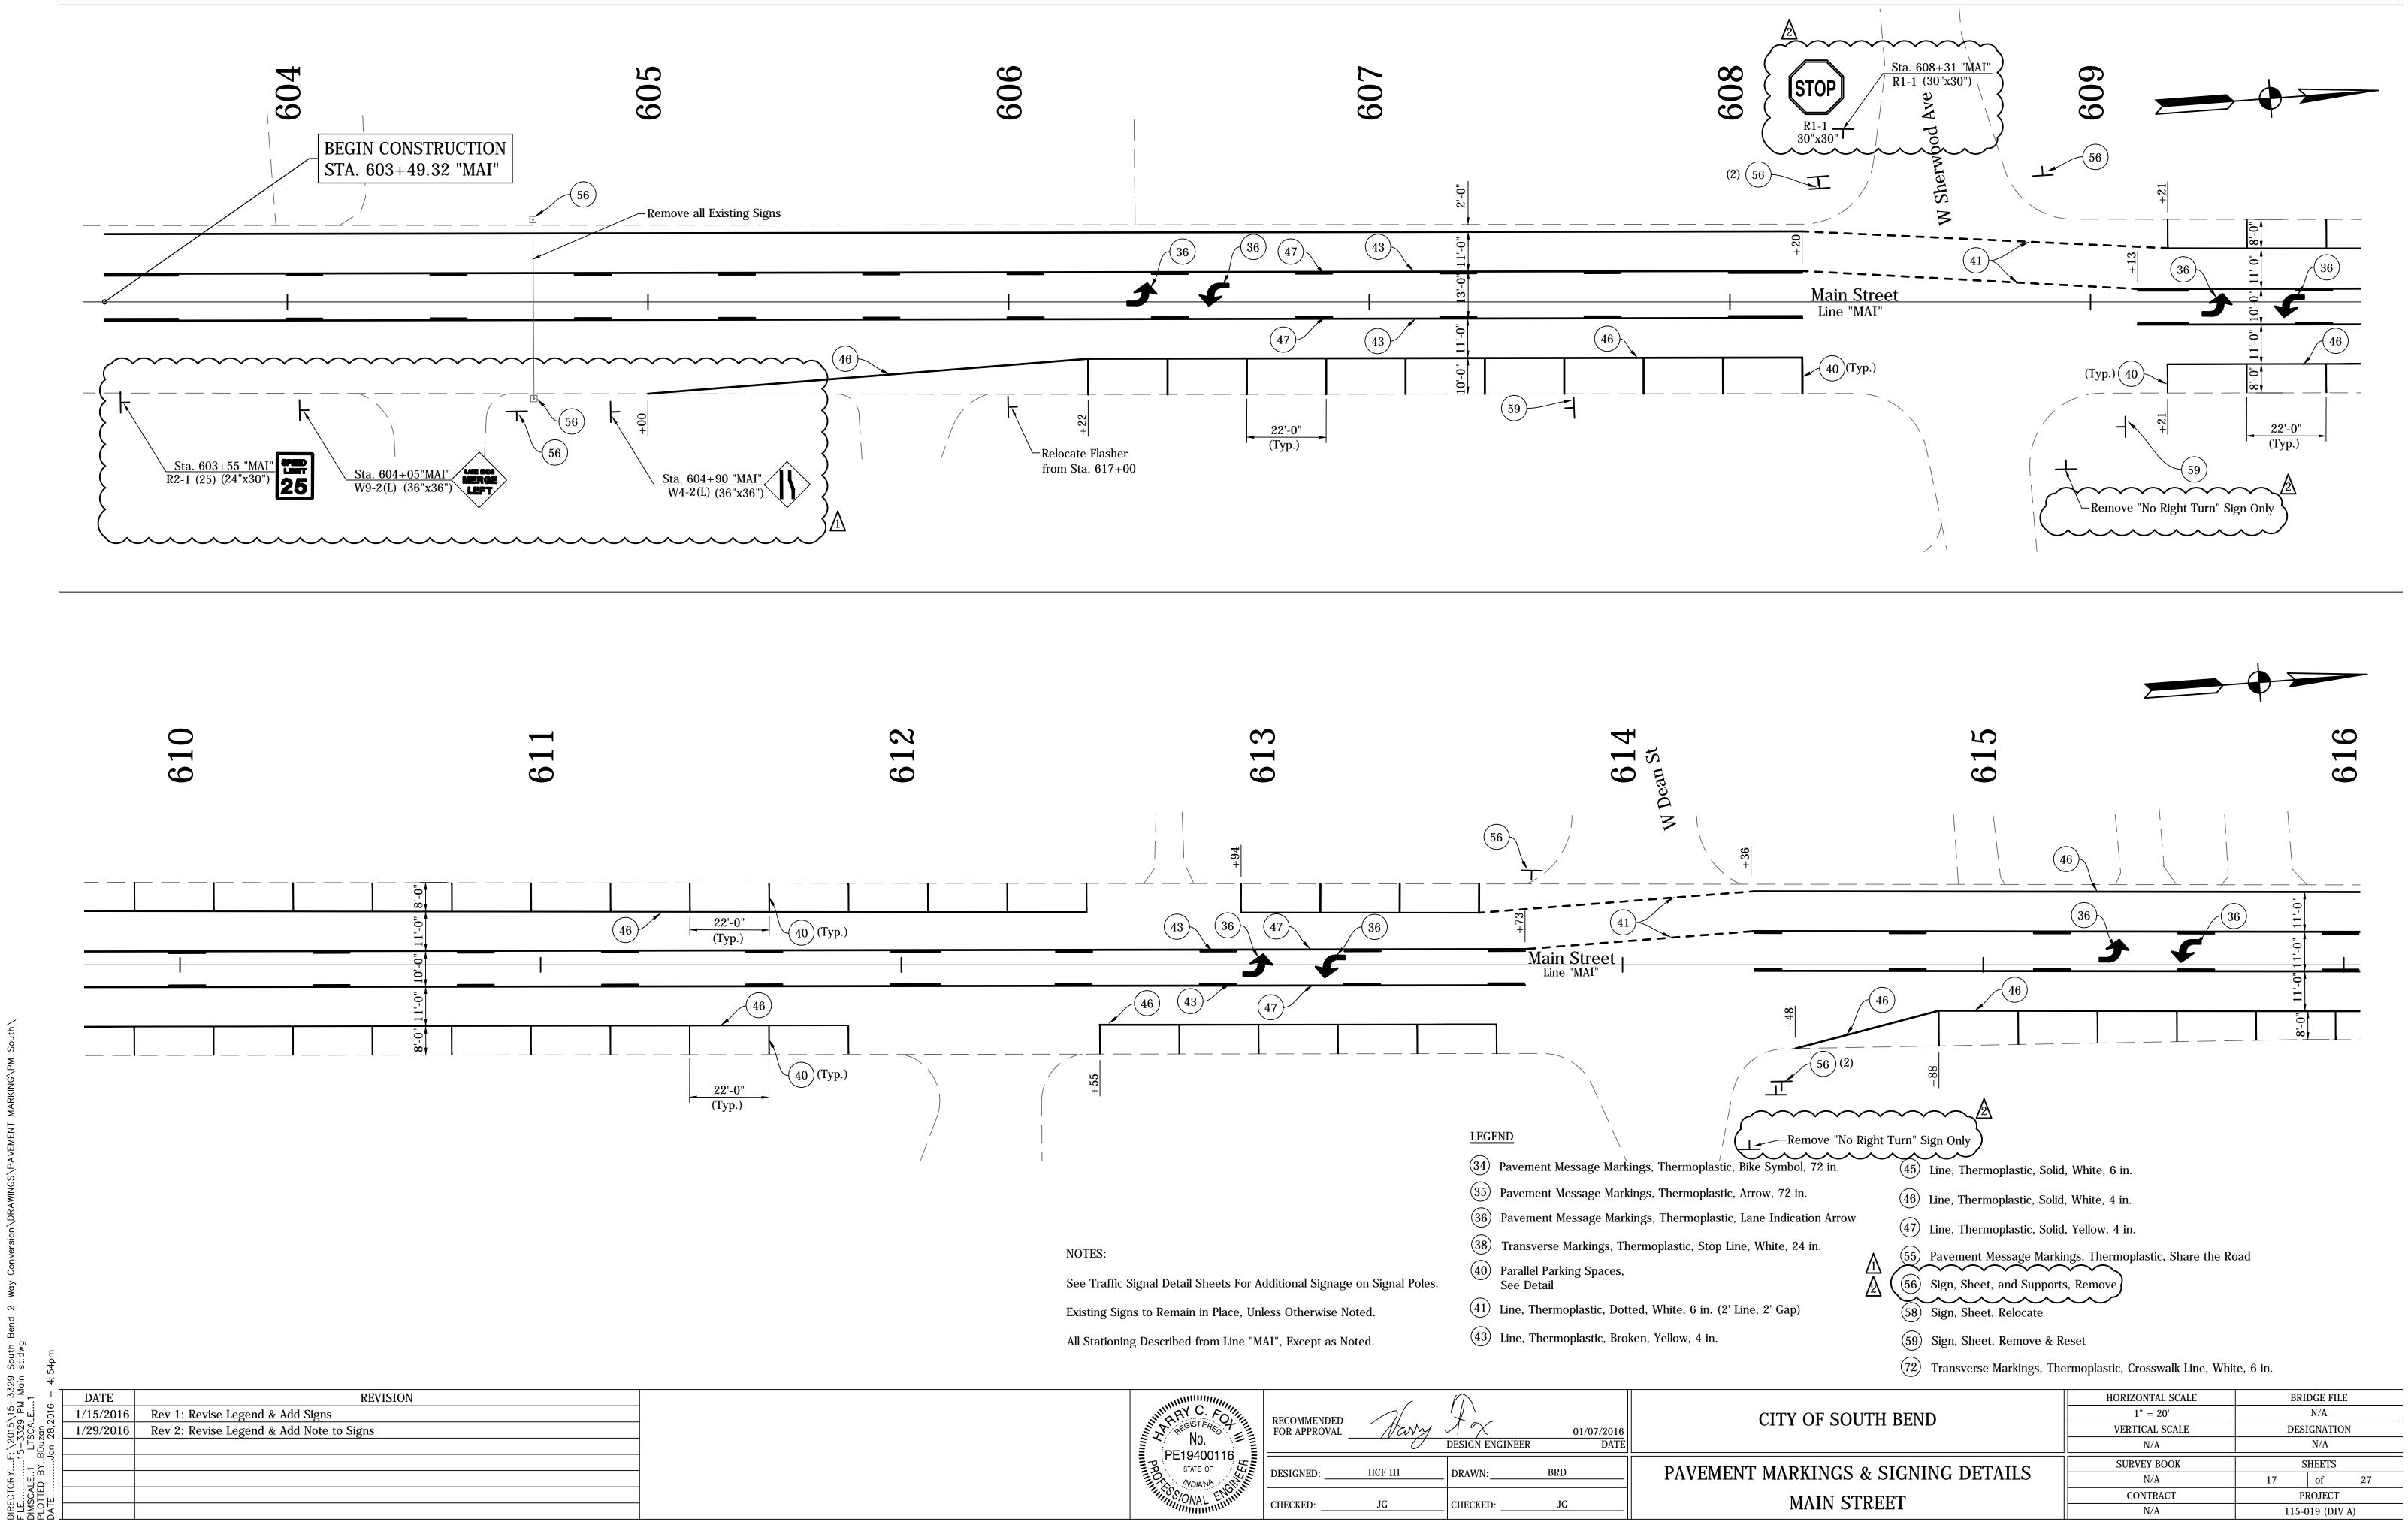

NO. PE19400116	RECOMMENDED FOR APPROVAL	Harry	DESIGN ENGINEER	01/07/2016 DATE	
PE19400110	DESIGNED:	HCF III	_ DRAWN:	BRD	PAVEMI
S/ONAL ENVIR	CHECKED:	JG	CHECKED:	JG	

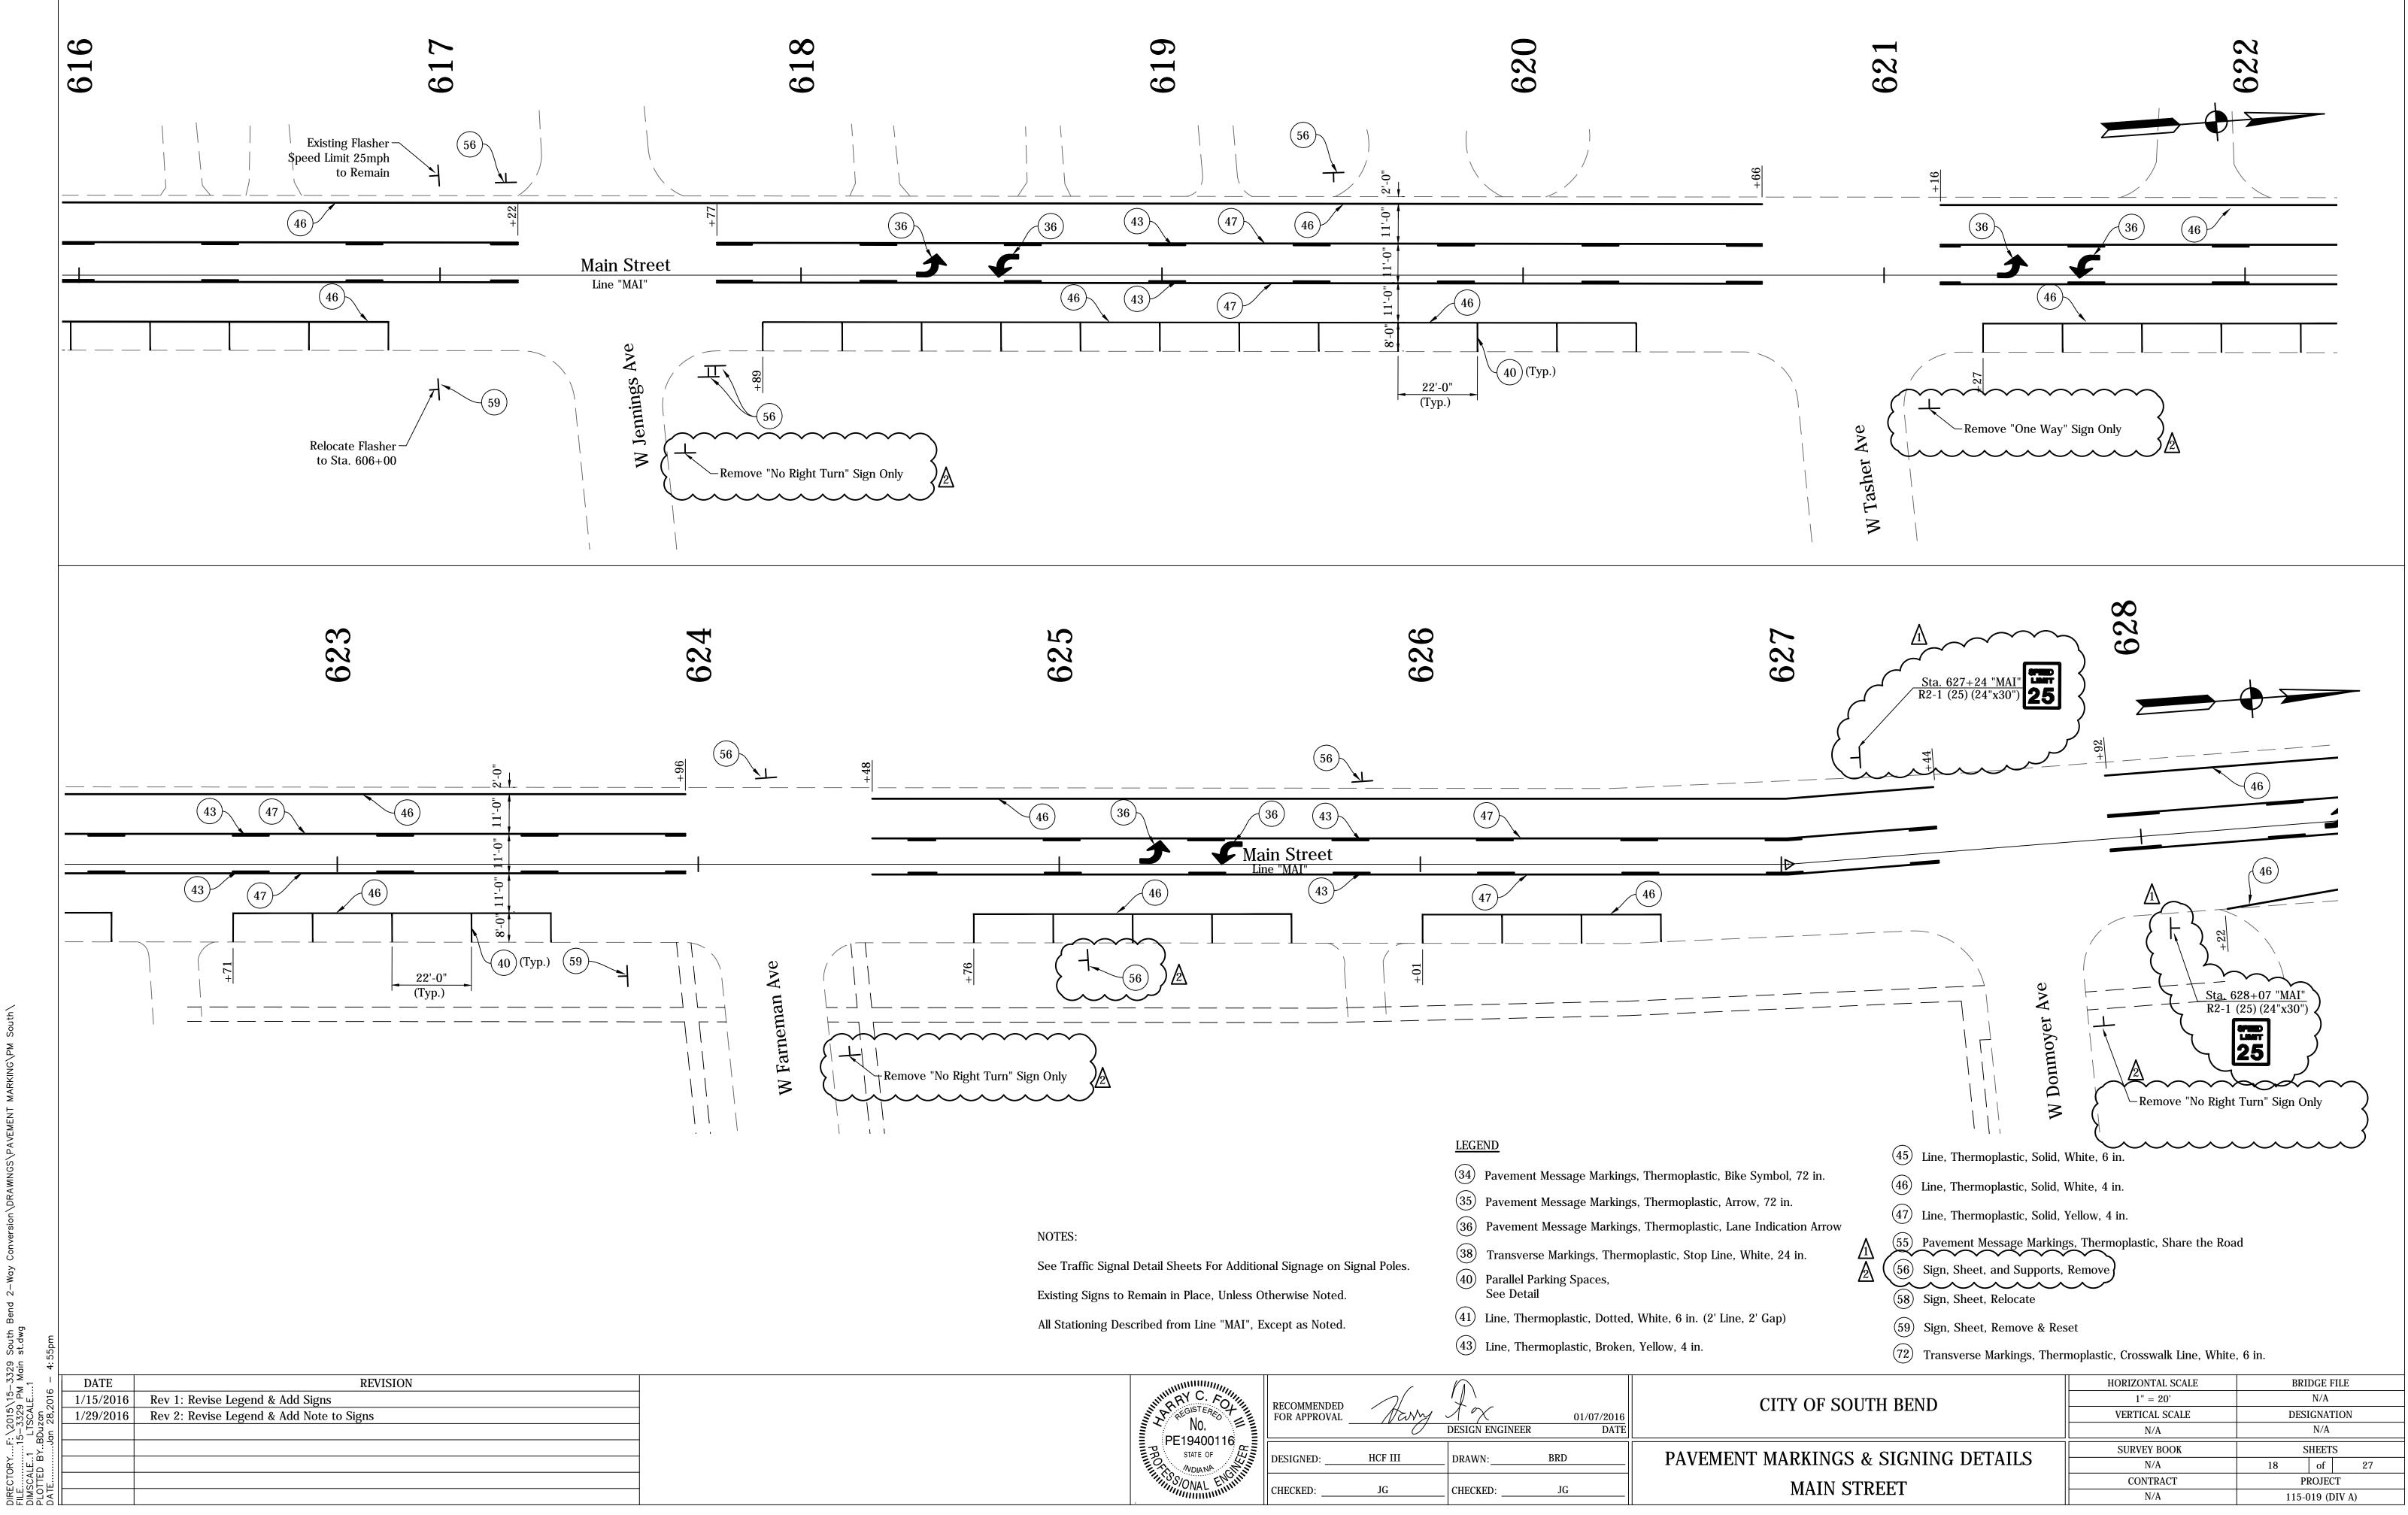


NO. PE19400116 STATE OF	RECOMMENDED FOR APPROVAL	Harry	DESIGN ENGINEER	01/07/2016 DATE	
	DESIGNED:	HCF III	_ DRAWN:	BRD	PAVEME
SONAL ENGINE	CHECKED:	JG	_ CHECKED:	JG	

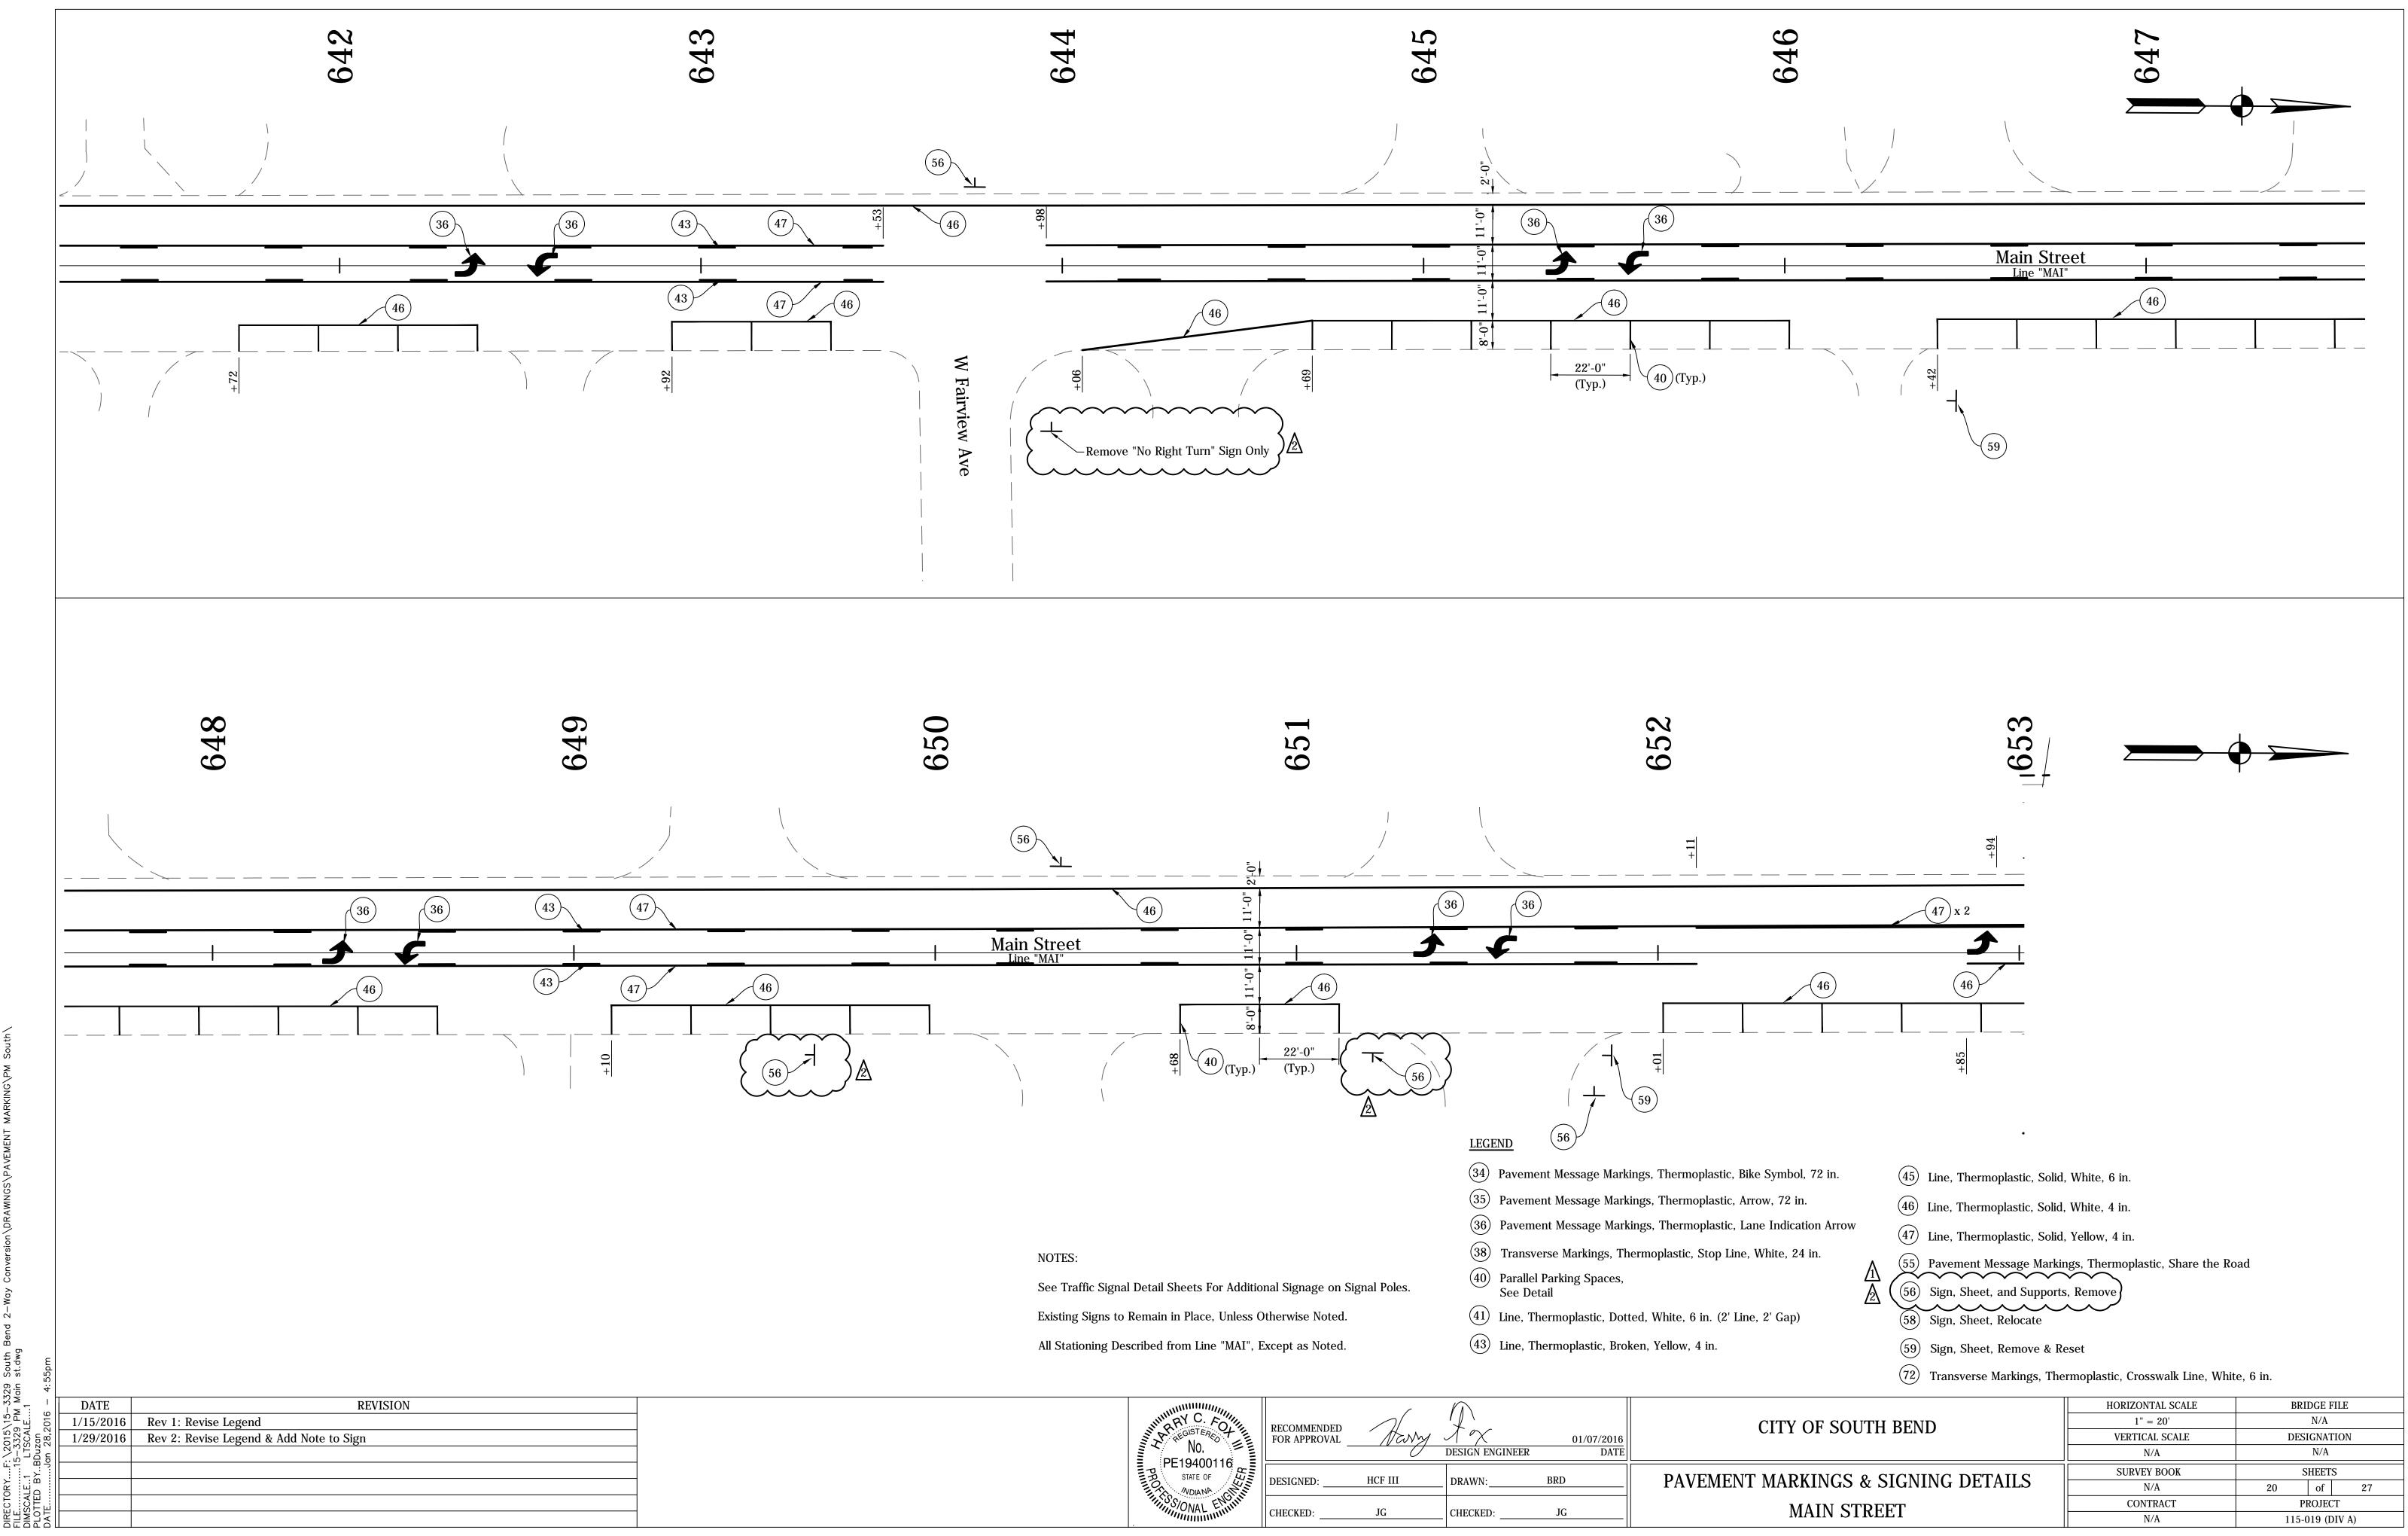


So st. 3329 Main 2015\1 3329 SCALF zr

BD_ 15-


HRY C. FOY	RECOMMENDED FOR APPROVAL	Harry	DESIGN ENGINEER	01/07/2016 DATE	
PE19400116 STATE OF	DESIGNED:	HCF III	_ DRAWN:	BRD	PAVEM
MINS/ONAL ENVIR	CHECKED:	JG	CHECKED:	JG	

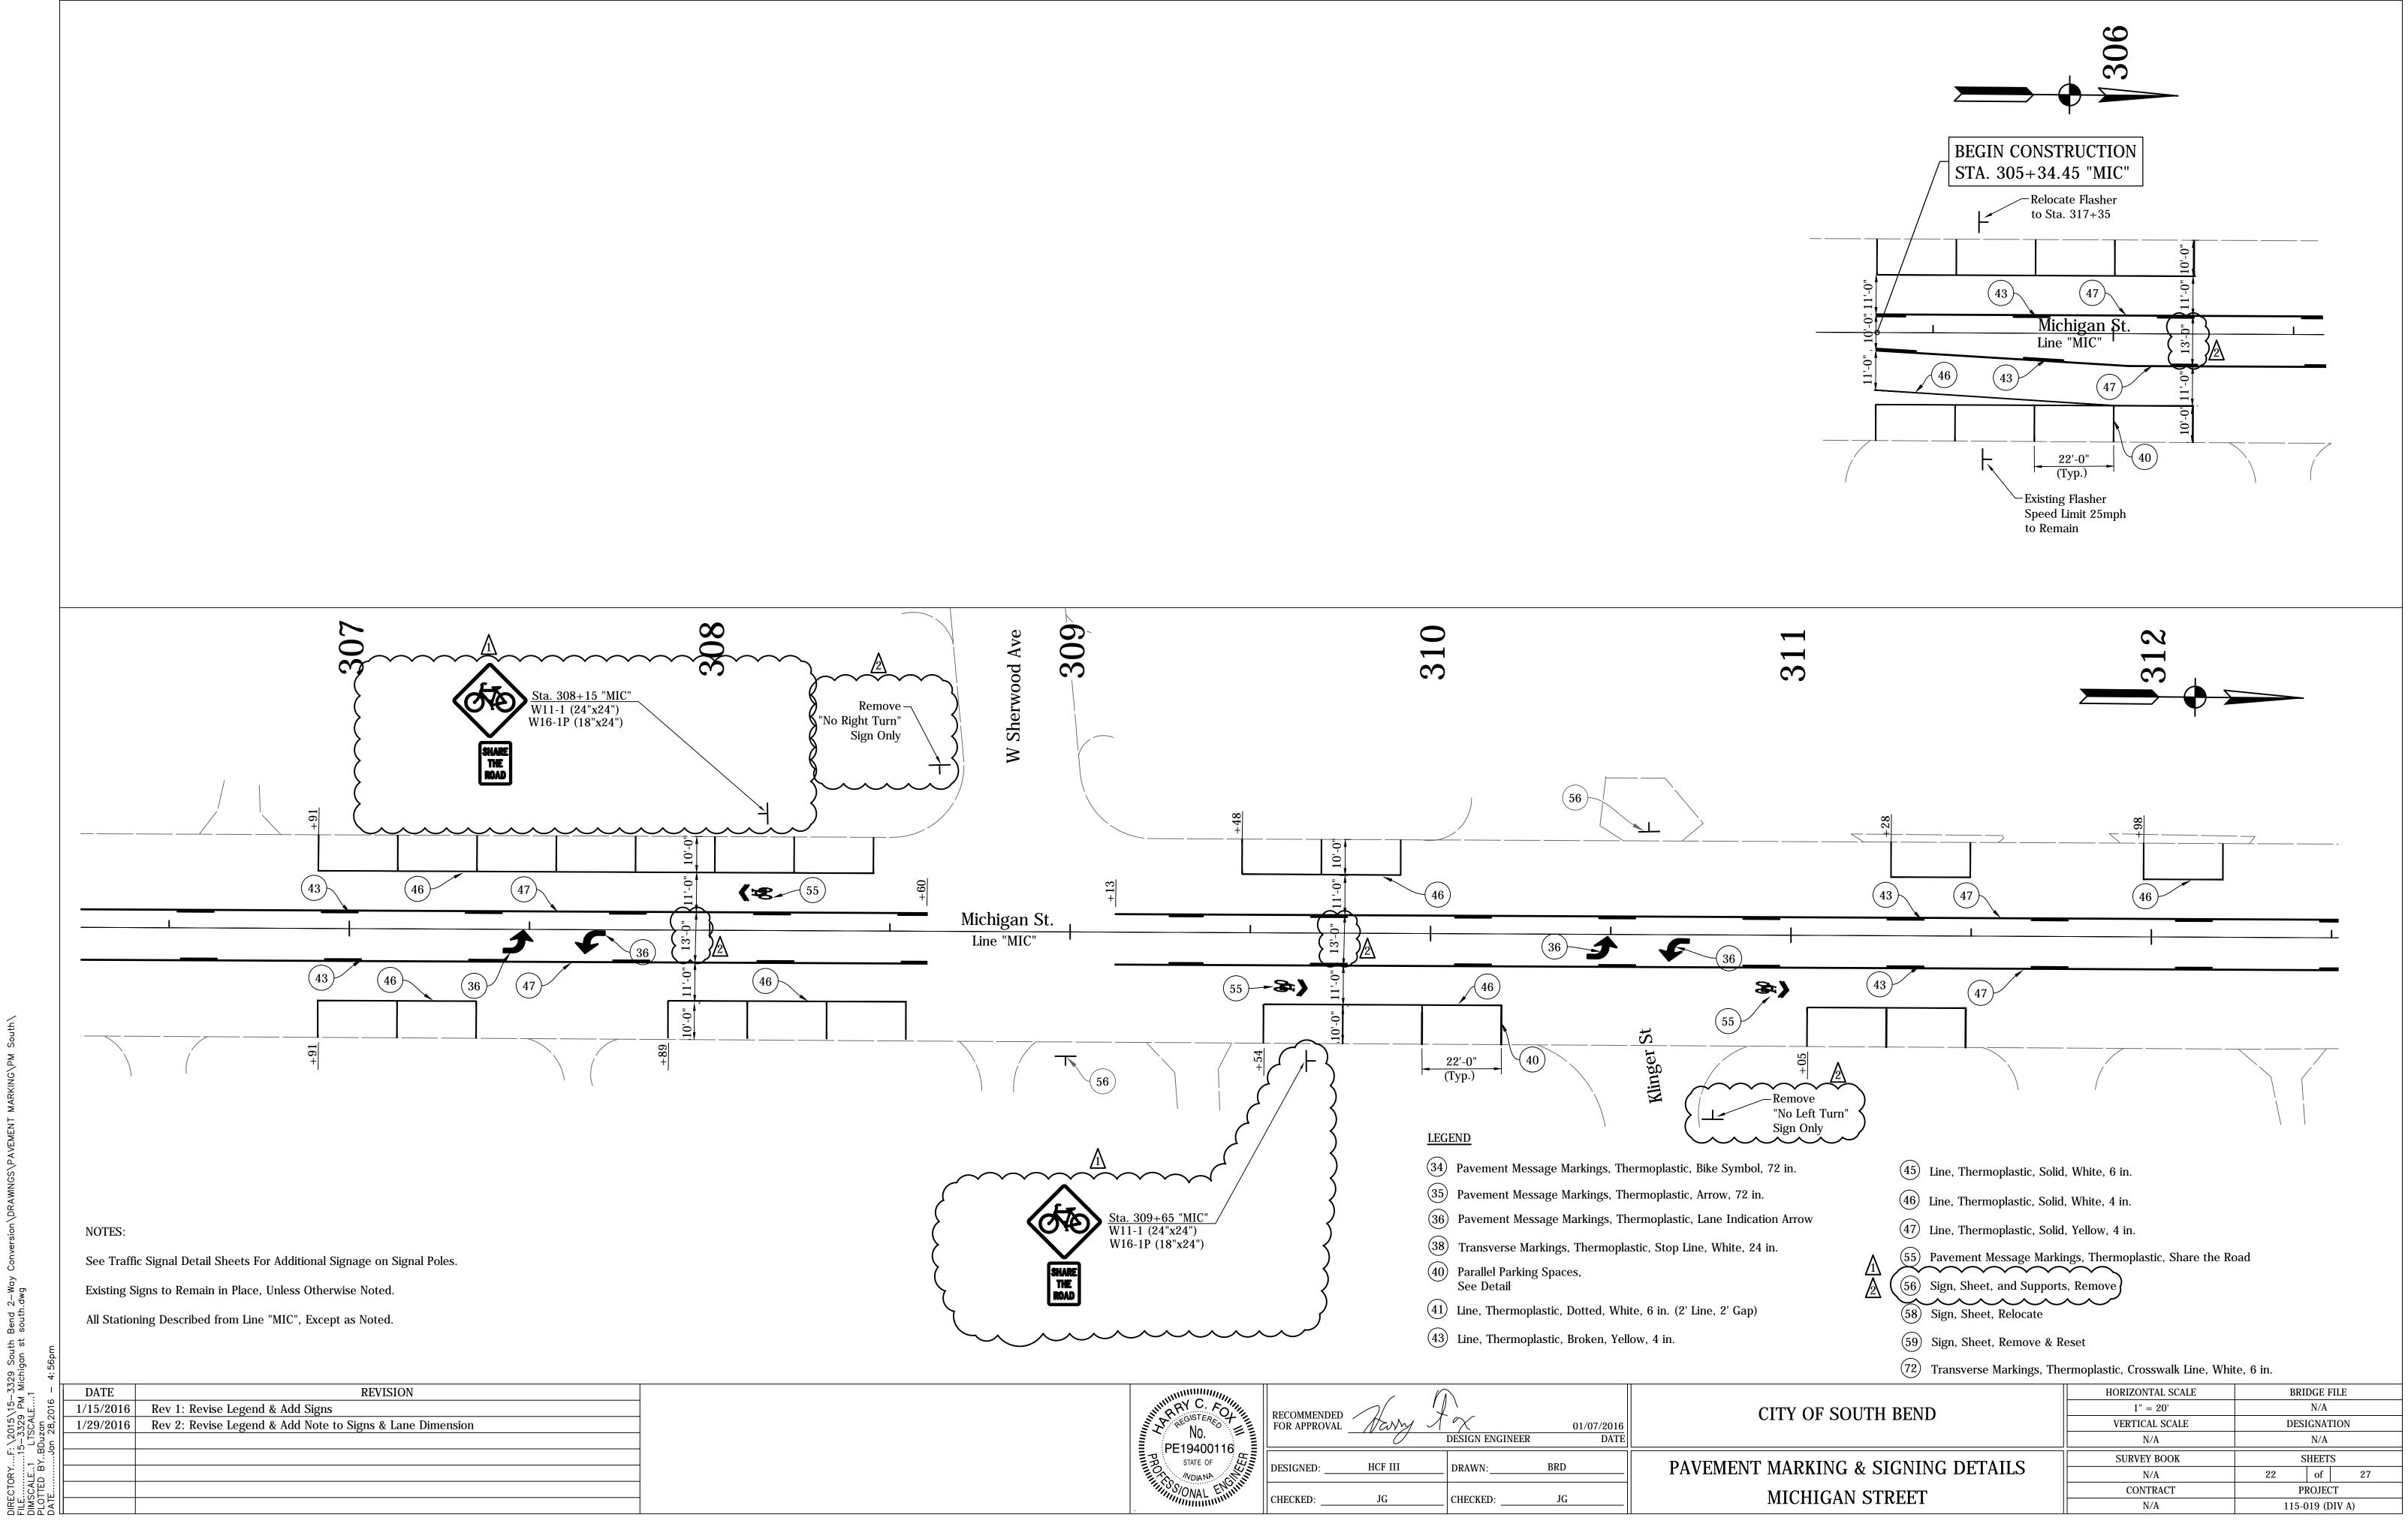


NO. PE19400116	RECOMMENDED FOR APPROVAL	Harry	DESIGN ENGINEER	01/07/2016 DATE	
PRO STATE OF	DESIGNED:	HCF III	DRAWN:	BRD	PAVEM
SONAL ENTIT	CHECKED:	JG	CHECKED:	JG	

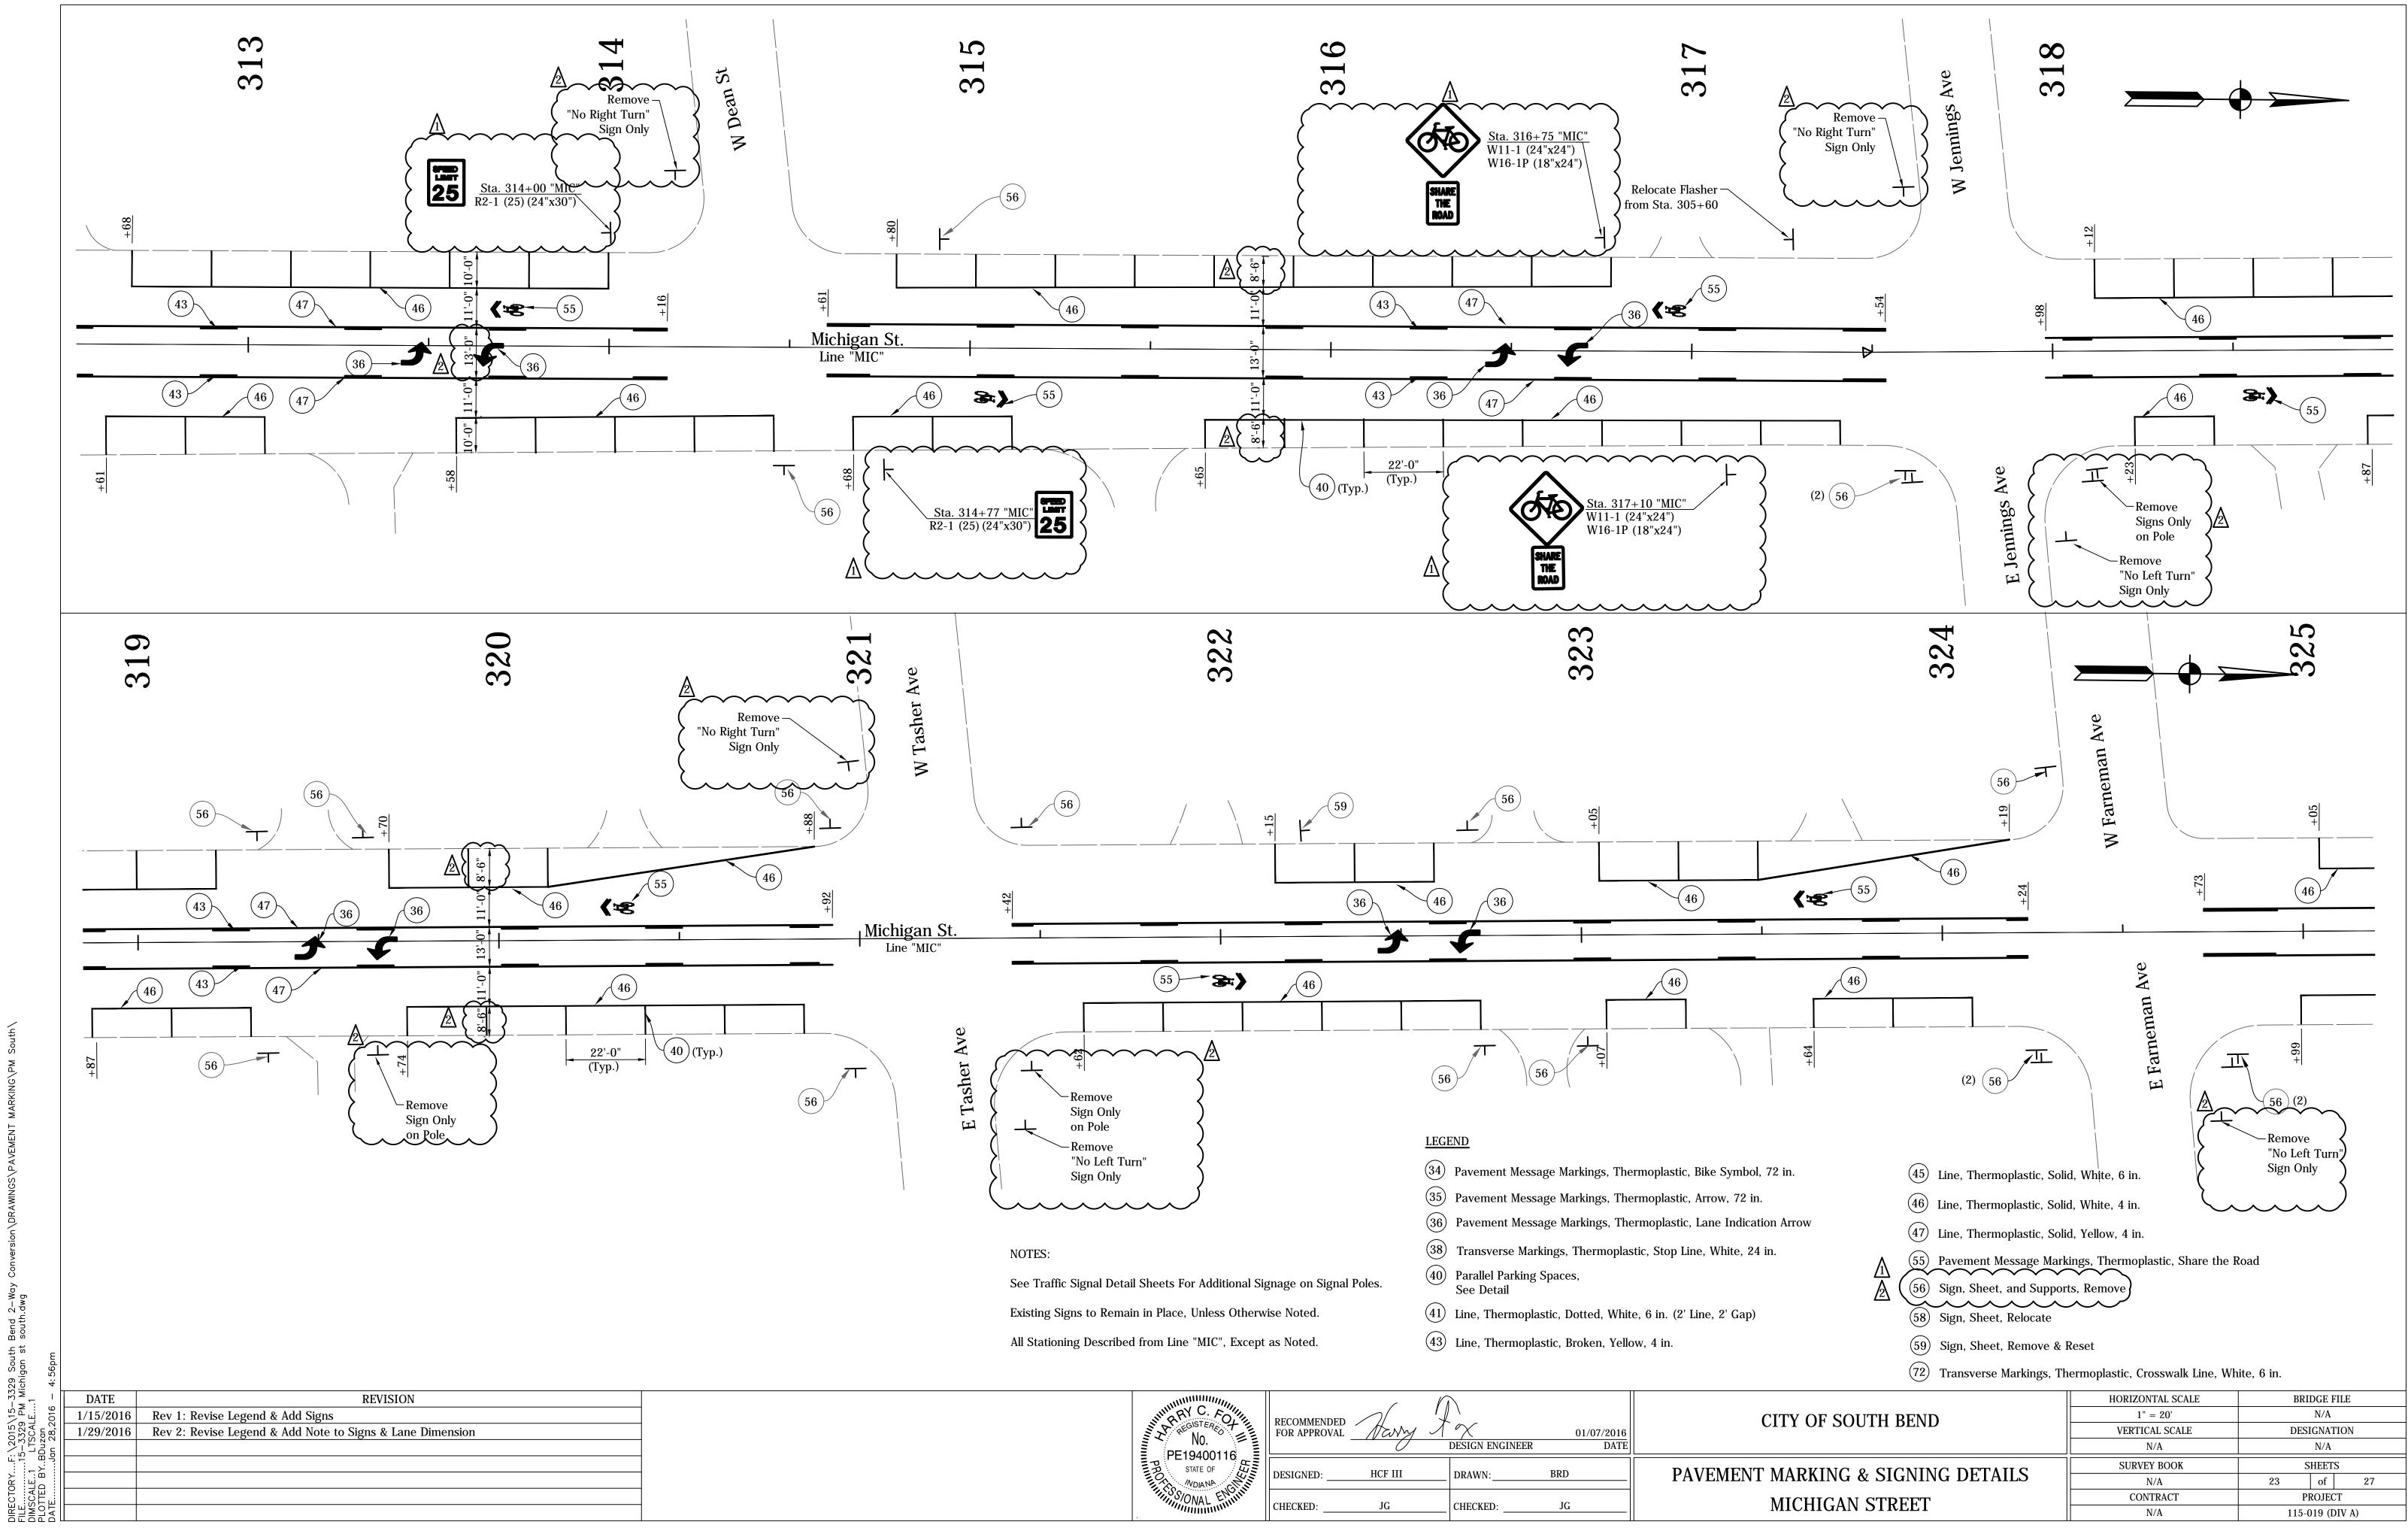


NO. PE19400116	RECOMMENDED FOR APPROVAL	Harry	DESIGN ENGINEER	01/07/2016 DATE	
PE19400116	DESIGNED:	HCF III	DRAWN:	BRD	PAVEME
110 S/ONAL ENDIN	CHECKED:	JG	CHECKED:	JG	

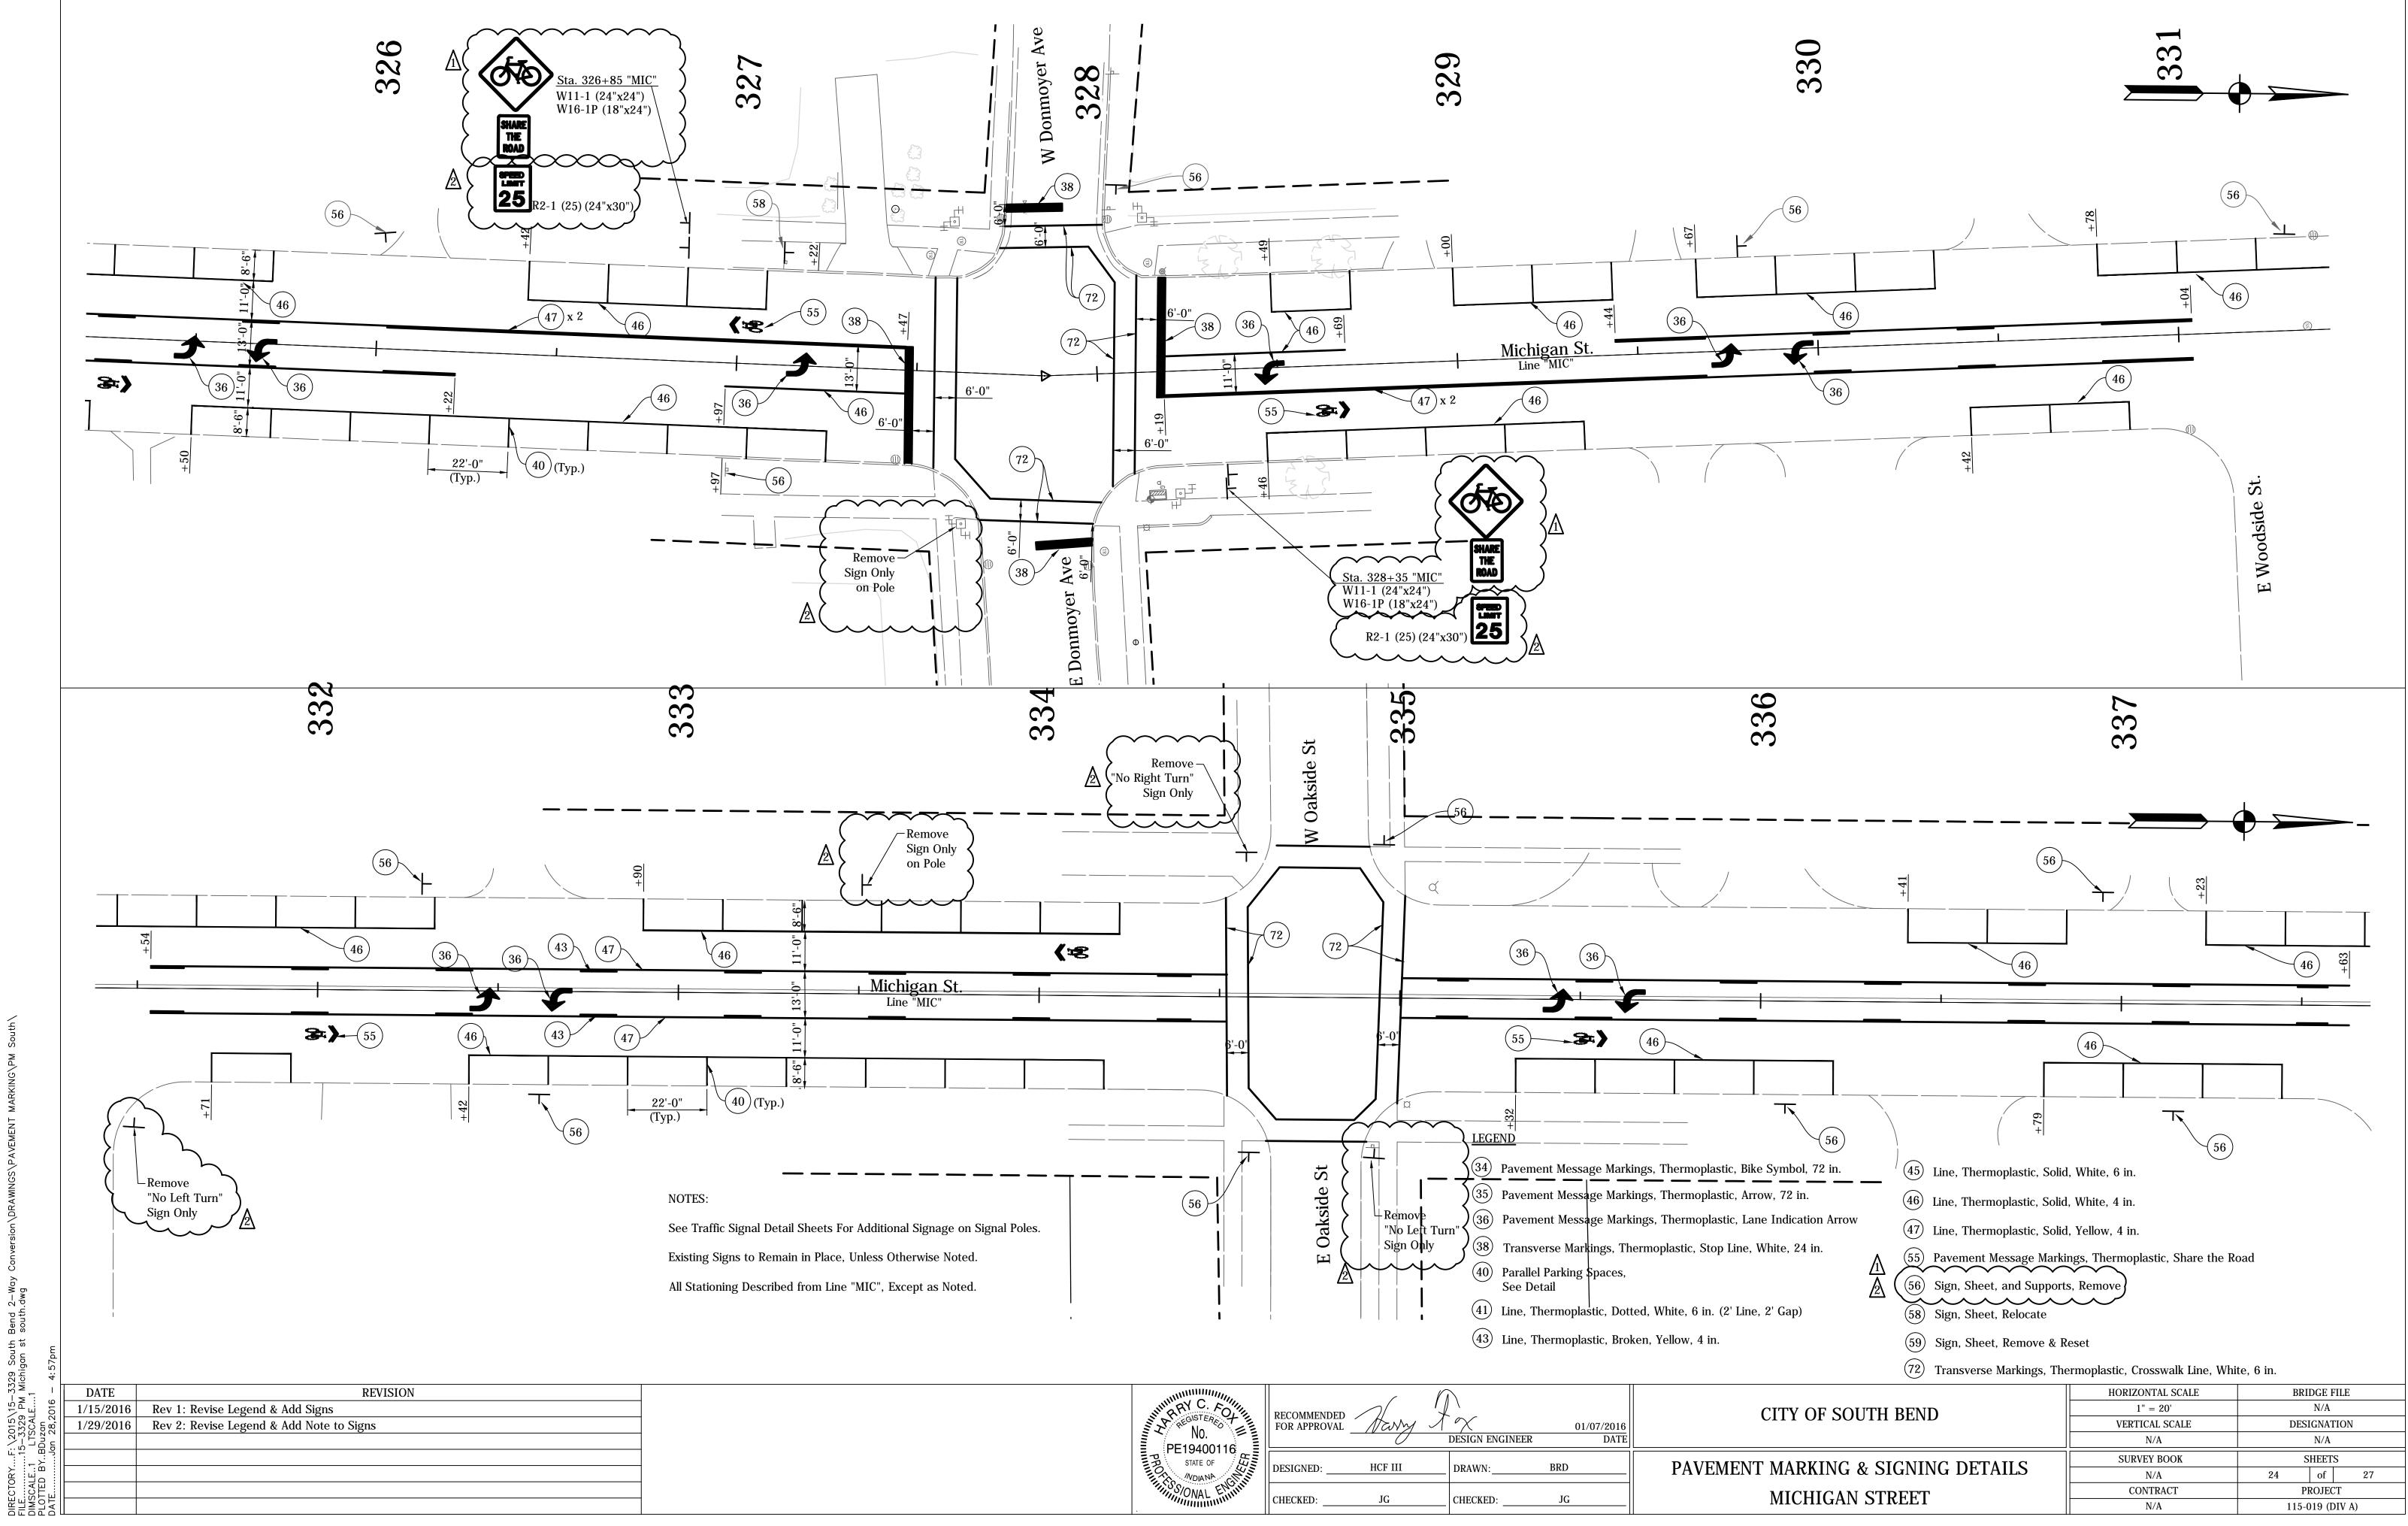

A PREGISTERED T	RECOMMENDED FOR APPROVAL	Harry	DESIGN ENGINEER	01/07/2016 DATE		
	PE19400116 STATE OF	DESIGNED:	HCF III	DRAWN:	BRD	PAVEN
	MUNICIONAL ENTRY	CHECKED:	JG	CHECKED:	JG	

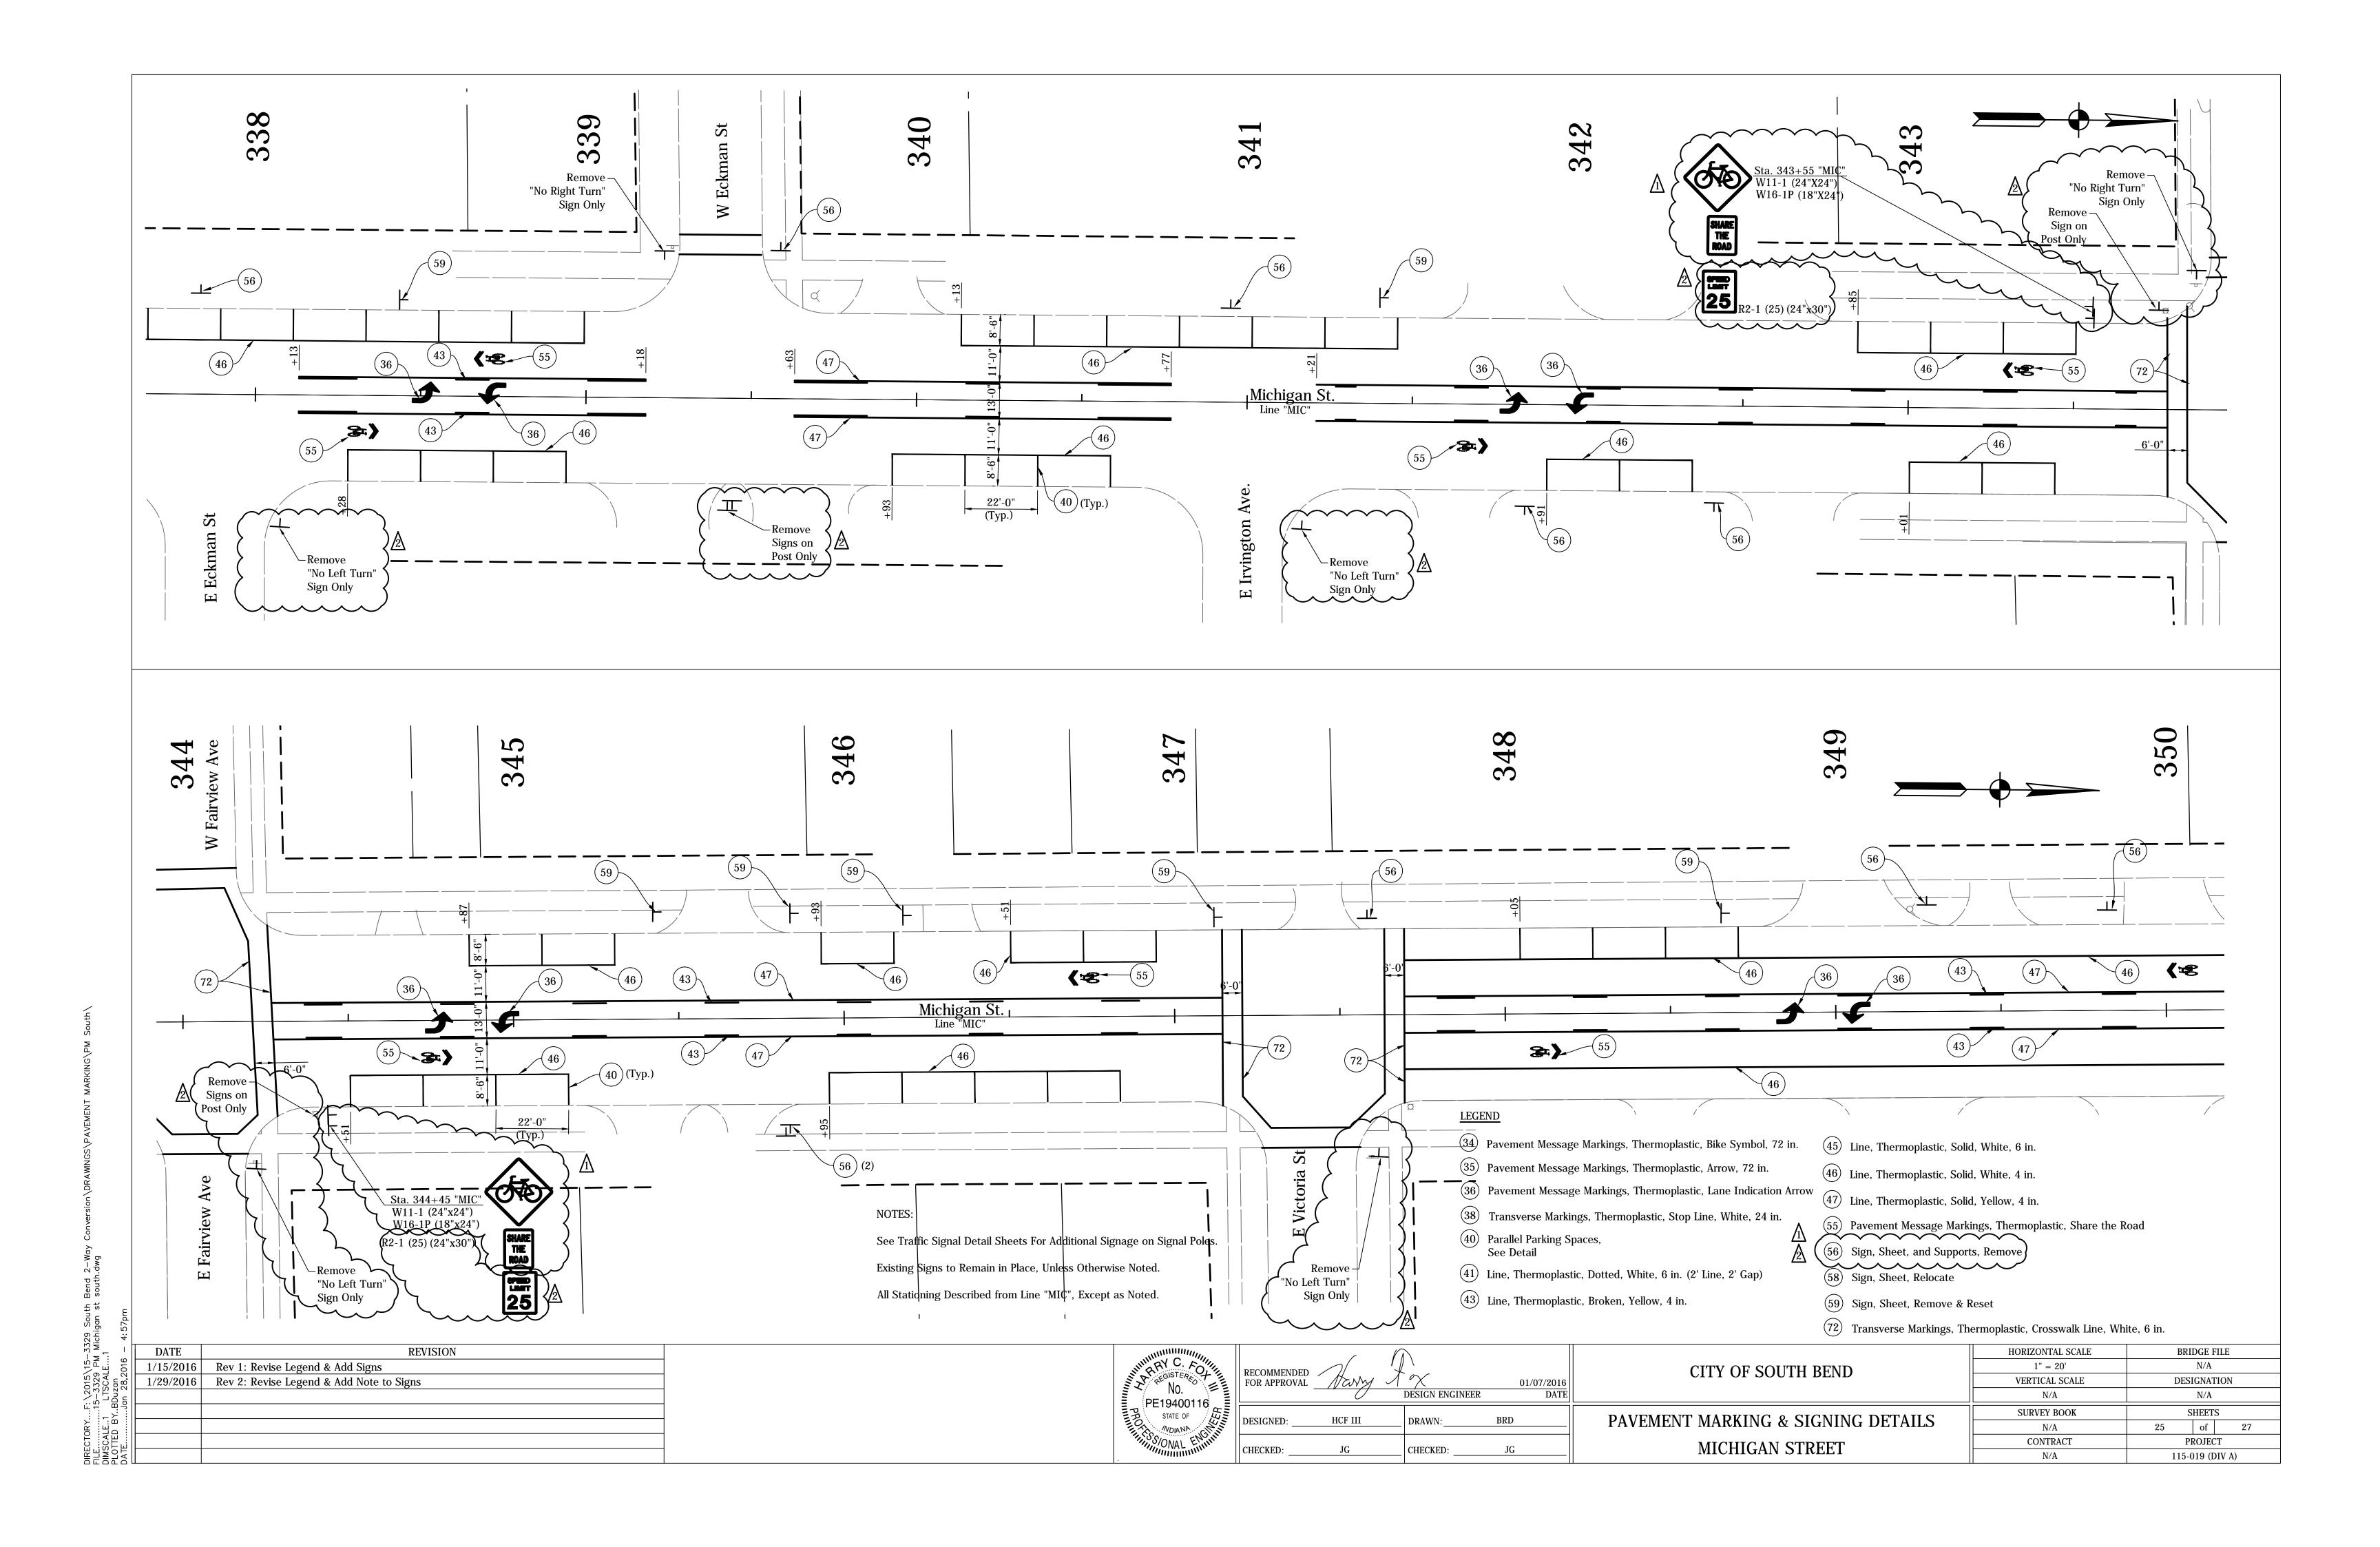

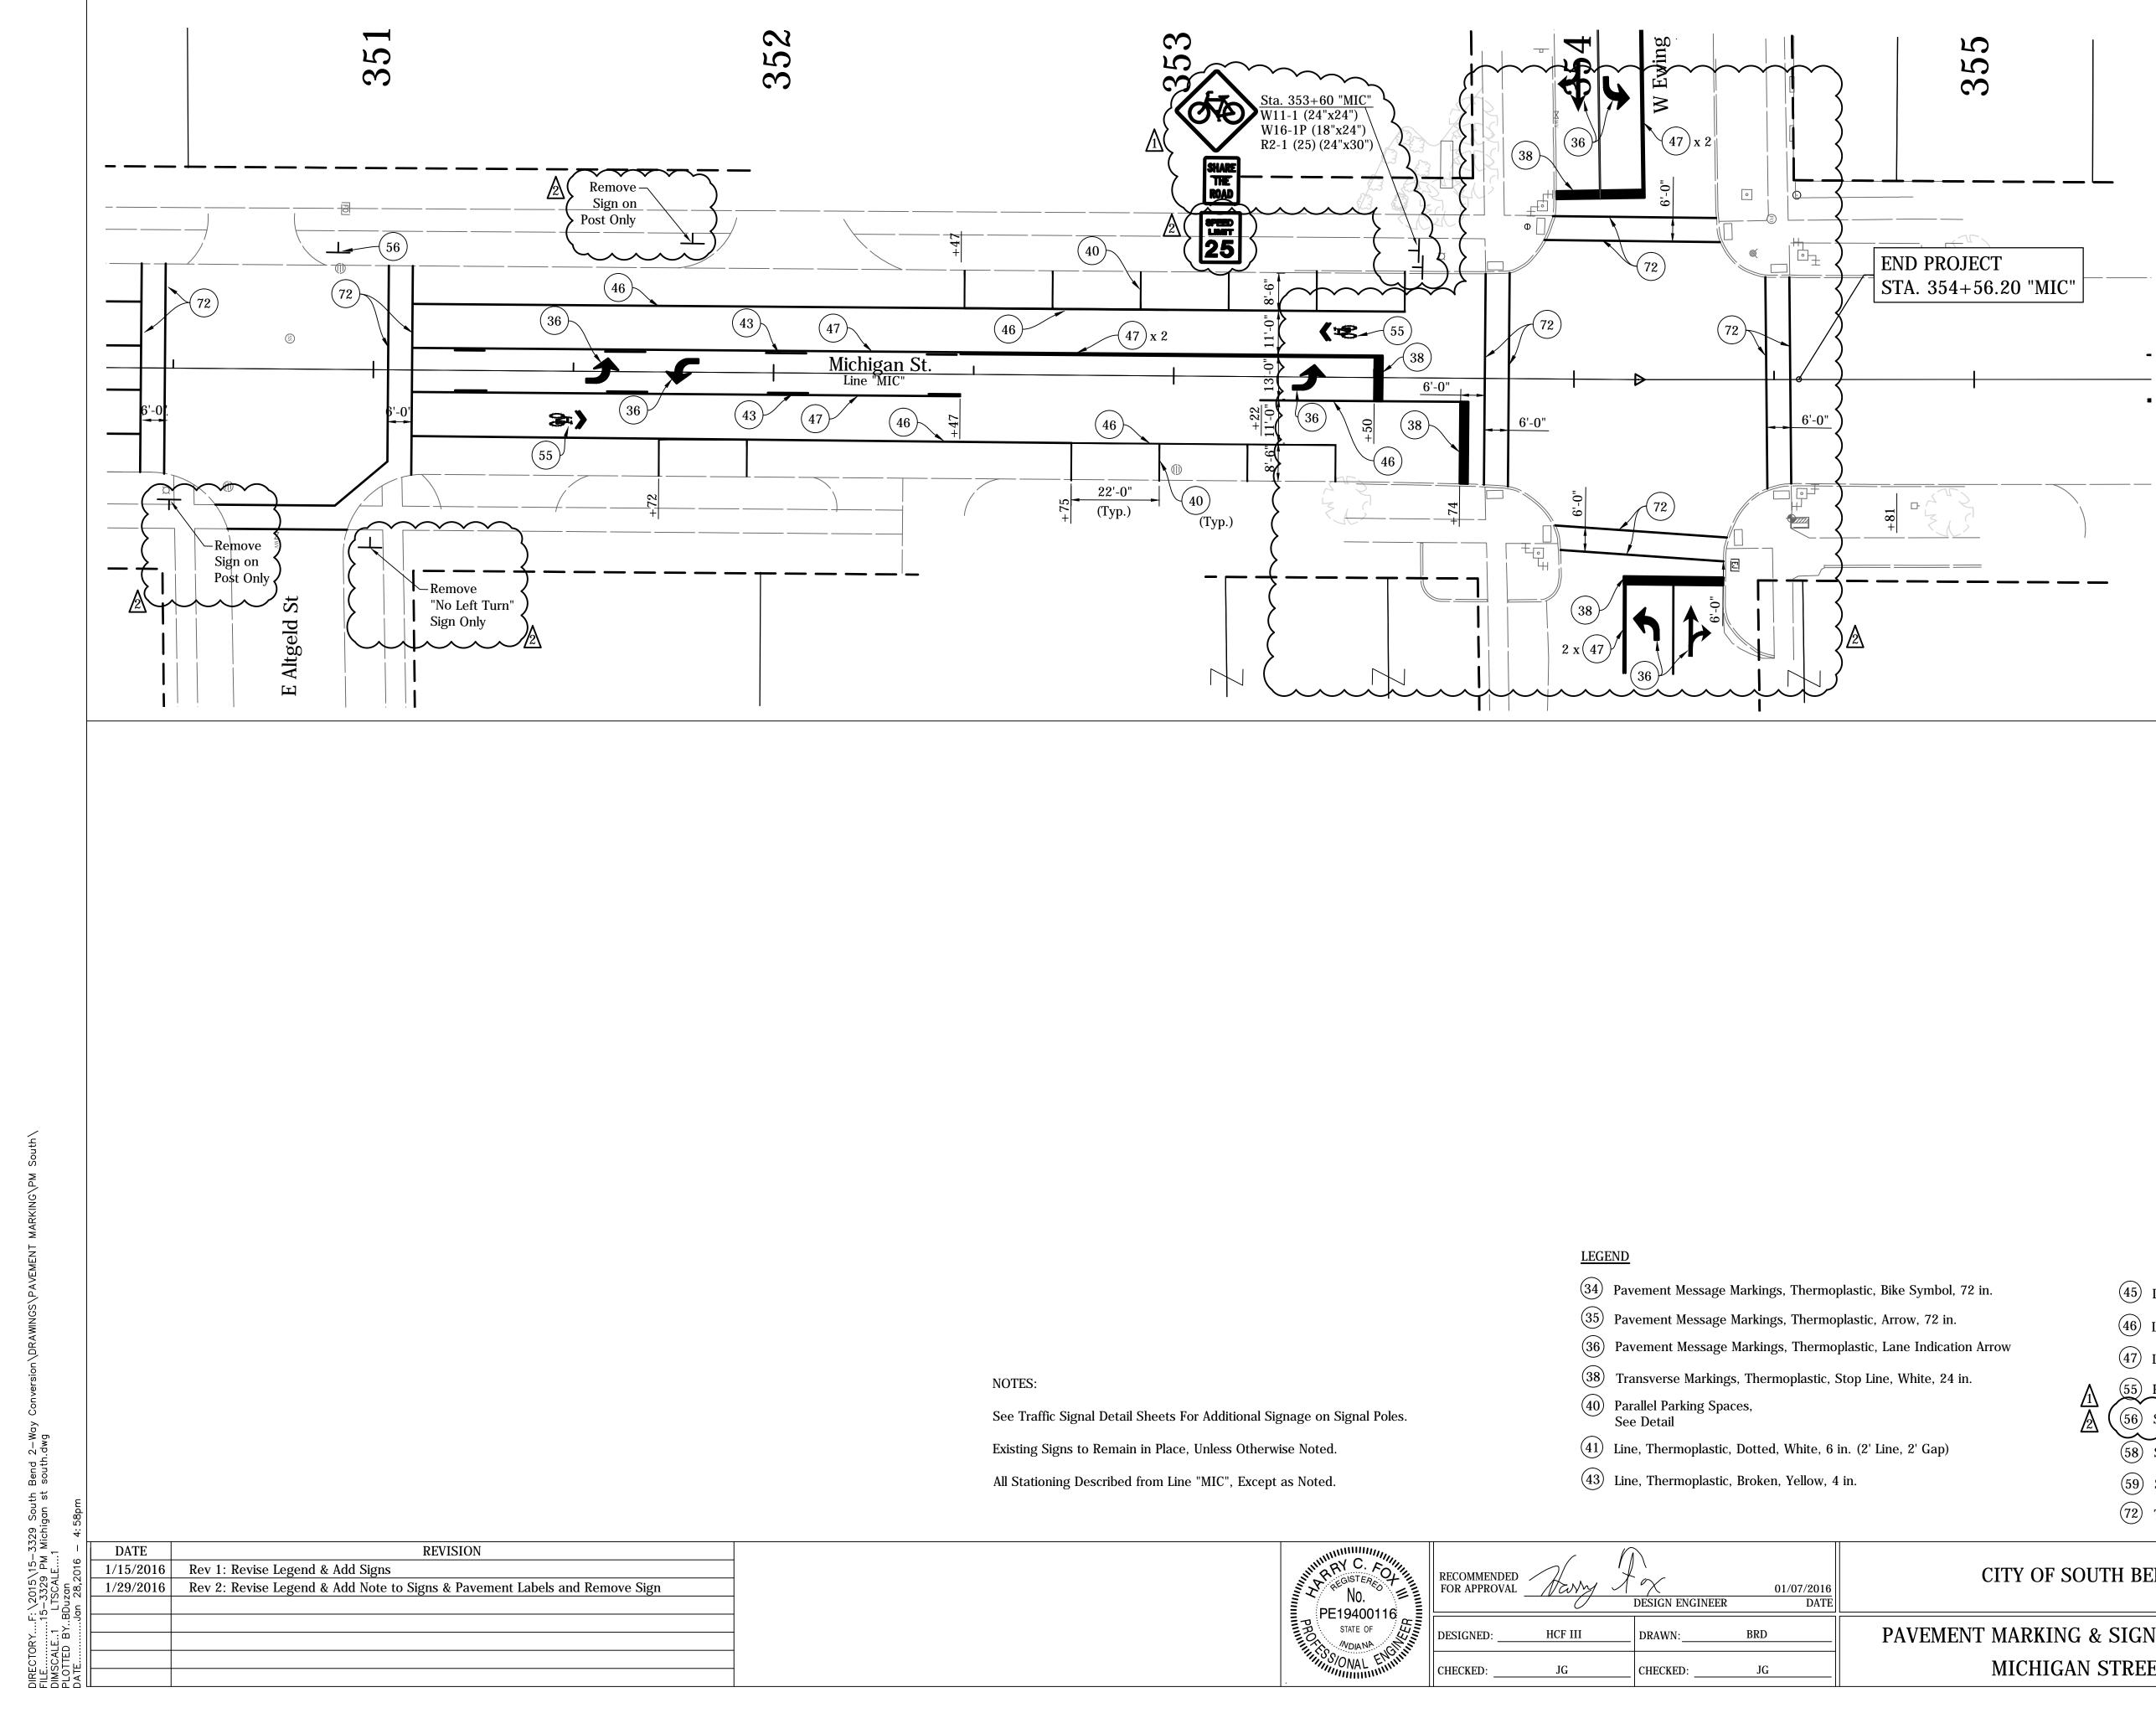

N0.	RECOMMENDED FOR APPROVAL	Harry	DESIGN ENGINEER	01/07/2016 DATE	
STATE OF	DESIGNED:	HCF III	DRAWN:	BRD	PAVEM
FINSSIONAL ENGINE	CHECKED:	JG	CHECKED:	JG	

- (45) Line, Thermoplastic, Solid, White, 6 in.
- 46 Line, Thermoplastic, Solid, White, 4 in.
- (47) Line, Thermoplastic, Solid, Yellow, 4 in.
- (55) Pavement Message Markings, Thermoplastic, Share the Road
- Sign, Sheet, and Supports, Remove
- 58) Sign, Sheet, Relocate
- 59) Sign, Sheet, Remove & Reset
- (72) Transverse Markings, Thermoplastic, Crosswalk Line, White, 6 in.

	HORIZONTAL SCALE	BRIDGE FILE		
CITY OF SOUTH BEND	1" = 20'		N/A	
	VERTICAL SCALE	DES	DESIGNATION	
	N/A	N/A		
MENT MADVING & CICNING DETAILS	SURVEY BOOK	SHEETS		5
MENT MARKING & SIGNING DETAILS	N/A	26	of	27
MICHIGAN STREET	CONTRACT	PROJECT		Т
WIICHIGAN SINEEI	N/A	115-019 (DIV A)		IV A)

SHEET SIGN & POST SUMMARY								SICN														
LINE	SIGN LOCATION	SIGN CODE	SIGN SIZE (IN x IN)	GROUN SIGN A	ID - MO REA (SI	UNTED FT)	2" x 2" - REINFO POST	<u>12 GA.</u> DRCED AN LENGTH	SC (TYPE 2) 2 NCHOR (FT)	QUARE 1/4" x 2 1/4" REINFORCI POST LEI	- 12 GA. (TYPE 1) ED ANCHOR NGTH (FT) TOTAL	LINE	SIGN LOCATION	N SIGN CODE	SIGN SIZE (IN x IN)	GROUN SIGN A	ND - MO AREA (SP	$\begin{array}{c} \text{UNTED} \\ \text{T} \\ \text{T} \\ \text{RE} \\ 0.125 \\ \text{H} \end{array}$	<u>x 2" - 12 GA</u> INFORCED POST LENGT	. (TYPE 2) ANCHOR 'H (FT)	SQUARE 2 1/4" x 2 1/4" REINFORCI POST LEN 1	- <u>12 GA. (TYI</u> ED ANCHOR IGTH (FT)
MAI	603+55	R2-1 (25)	24 x 30	5.0	0.100	0.125	1	2	ŤOŤAL	1 9.5	TOTAL 9.5	MIC	353+60	W11-1 W16-1P	24 x 24 18 x 24	4.0	0.100	0.125	1 2	TOTAL	1 13.0	TOTA 13.0
MAI	604+05	W9-2(L)	36 x 36		9.0					10	10	MIC	353+60		24 x 30						9.5	9.5
MAI	604+90	W4-2(L)	36 x 36		9.0					12.5	12.5	SUBTOTALS				12.0						22.5
MAI	608+31	R1-1	30 x 30	6.3						10	10	TOTALS					45.0					251.5
MAI	627+24	R2-1 (25)	24 x 30	5.0						9.5	9.5	-										
MAI	628+07	R2-1 (25)	24 x 30	5.0						9.5	9.5	-										
MAI	653+04	R2-1 (25)	24 x 30	5.0						9.5	9.5	-										
MAI	653+30	R3-7	30 x 30	6.3						10	10	-										
MAI		R3-1	36 x 36		9.0		MA	ST ARM .	AT EWING			-										
MAI		R3-2	36 x 36		9.0		MA	ST ARM	AT EWING			-										
MAI		R5-1	36 x 36		9.0		MA	ST ARM	AT EWING			-										
MIC	308+15	W11-1	24 x 24							13.0	13.0	-										
		W16-1P	18 x 24	3.0								-										
MIC	309+65	W11-1	24 x 24	-						13.0	13.0											
		W16-1P	18 x 24	3.0								-										
MIC	314+00	R2-1 (25)	24 x 30	5.0						9.5	9.5	-										
MIC	314+77	R2-1 (25)	24 x 30	5.0						9.5	9.5	-										
MIC	316+75	W11-1	24 x 24	-						13.0	13.0											
		W16-1P	18 x 24	3.0																		
MIC	317+10	W11-1	24 x 24							13.0	13.0	-										
		W16-1P	18 x 24	3.0								-										
MIC	326+85	R2-1 (25)	24 x 30	5.0						9.5	9.5	-										
MIC	326+85	W11-1	24 x 24	-						13.0	13.0	-										
		W16-1P	18 x 24	3.0																		
MIC	328+35	R2-1 (25)	24 x 30	5.0						9.5	9.5											
MIC	328+35	W11-1	24 x 24							13.0	13.0											
		W16-1P	18 x 24	3.0																		
MIC	343+55	R2-1 (25)	24 x 30	5.0						9.5	9.5											
MIC	343+55	W11-1	24 x 24	4.0						13.0	13.0											
		W16-1P	18 x 24																			
MIC	344+45	R2-1 (25)	24 x 30	5.0						9.5	9.5	1										
MIC	344+45	W11-1 W16-1P	24 x 24 18 x 24	_						13.0	13.0	-										
SUBTOTALS					45.0						229.0	-										
		1	1						I			L										

CALE. 1 TED BY... DIRECT FILE.... DIMSC/ PLOTTI

DATE 1/29/2016 Rev 2: Add Sheet REVISION

THUMMARY C. FOIL	RECOMMENDED FOR APPROVAL	01/07/2016 DATE			
PE19400116 STATE OF	DESIGNED:	HCF III	DRAWN:	BRD	
MOS/ONAL ENVIR	CHECKED:	JG	CHECKED:	JG	

	HORIZONTAL SCALE	BRIDGE FILE			
CITY OF SOUTH BEND		N/A			
CITI OF SOUTH DEND	VERTICAL SCALE	DESIGNATION			
		N/A			
	SURVEY BOOK	SHEETS			
SHEET SIGN & POST SUMMARY	N/A	26-1	of	27	
SHEET SIGN & PUST SUMMART	CONTRACT	PROJECT			
	N/A	115-	DIV A)		