



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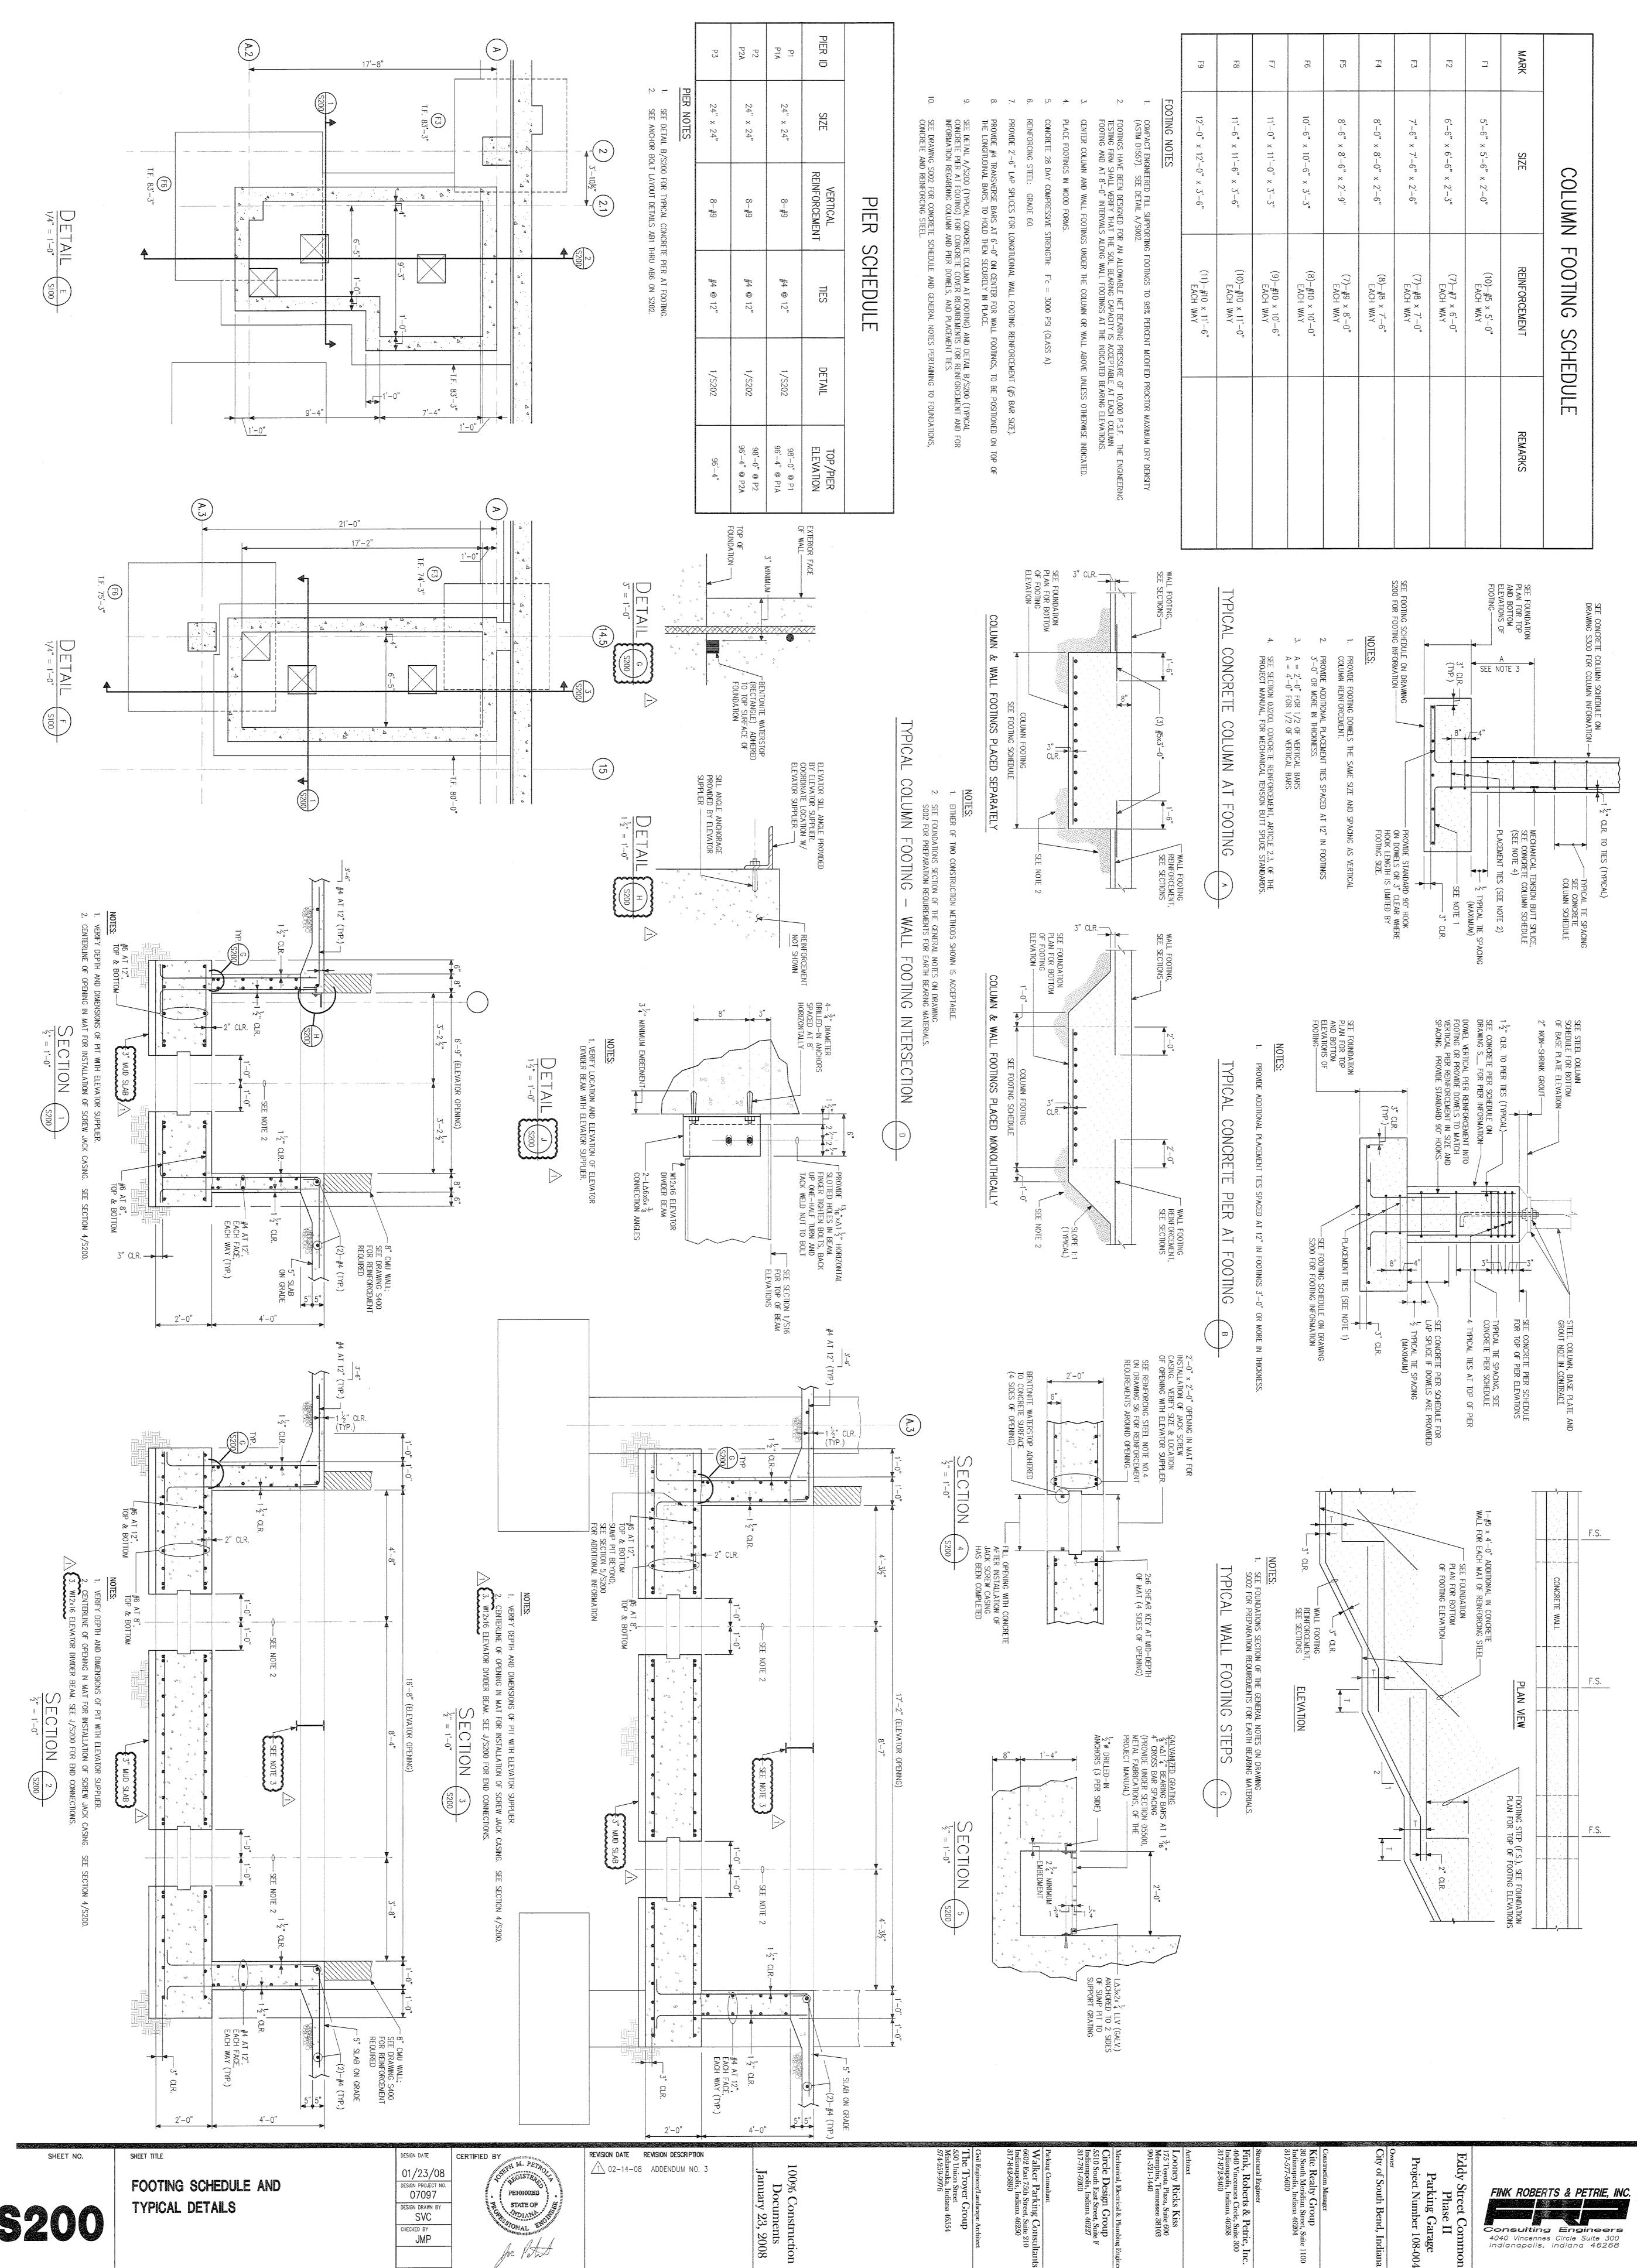
DESIGN DATE

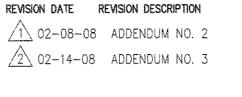

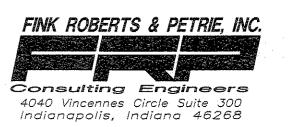

Owner
City of South Bend, Indiana

SHEET TITLE





Consulting Engineers


4040 Vincennes Circle Suite 300 Indianapolis, Indiana 46268


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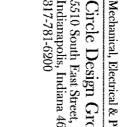
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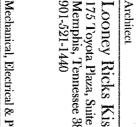





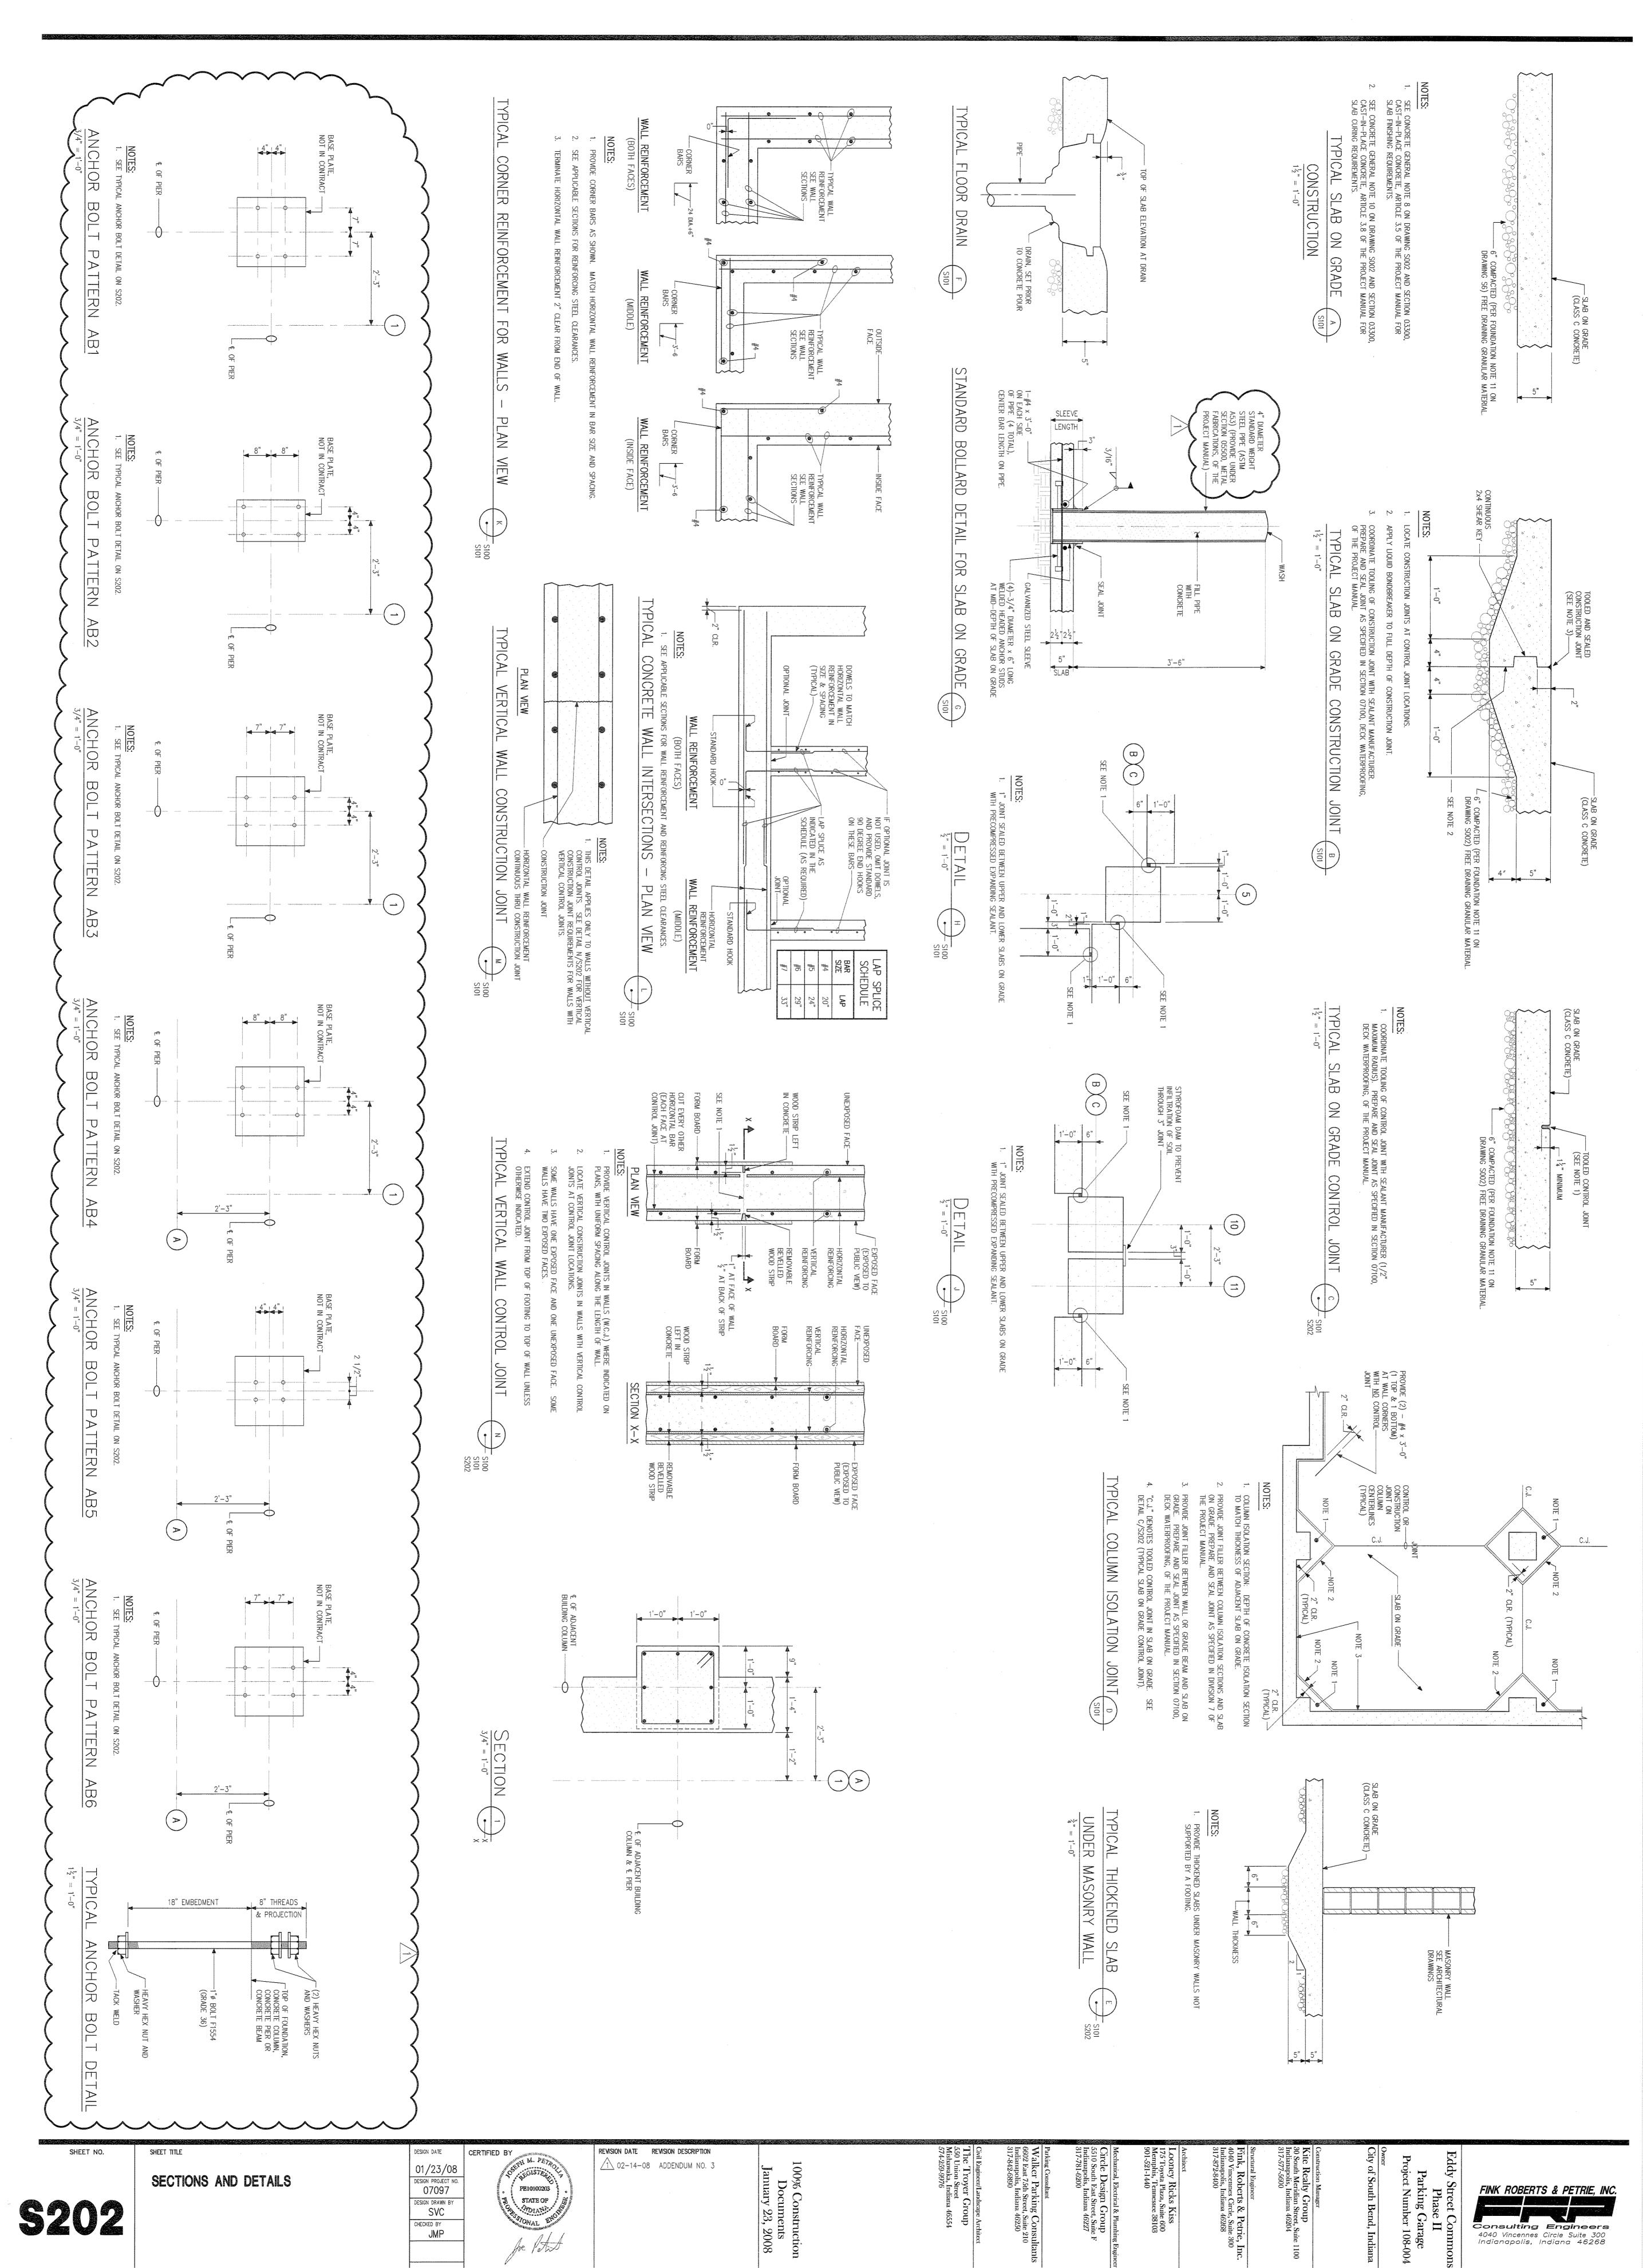


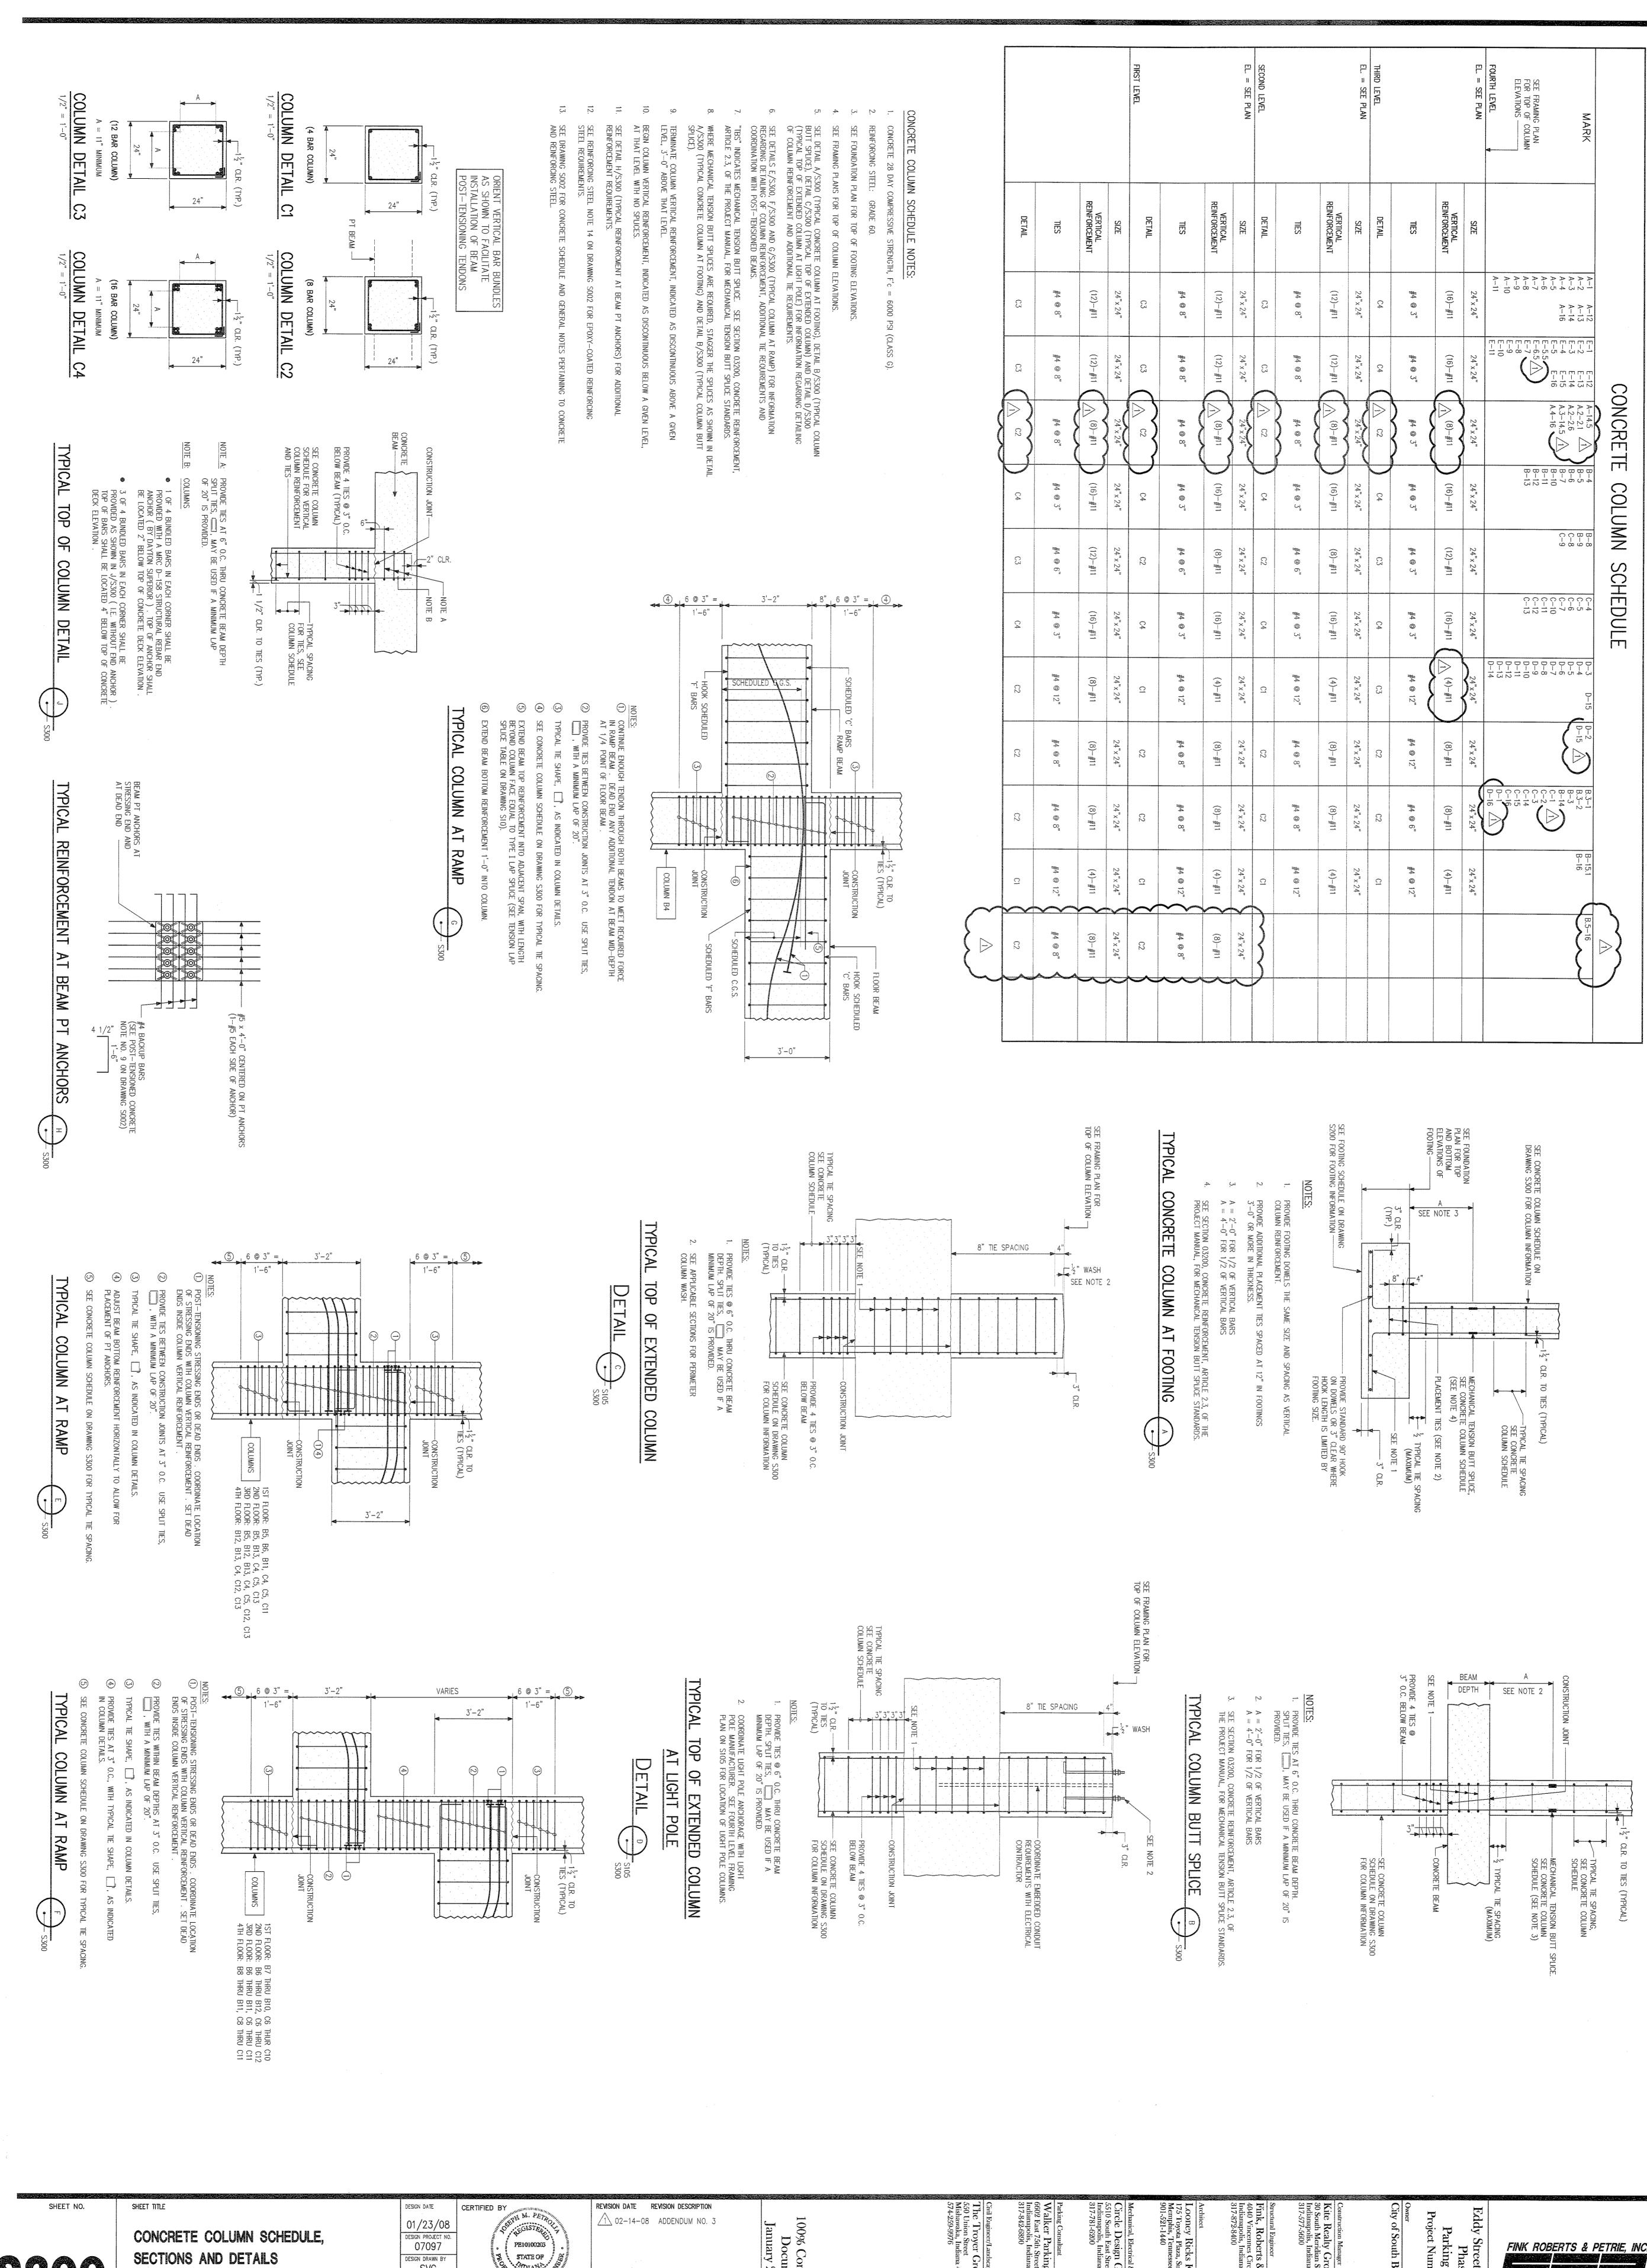


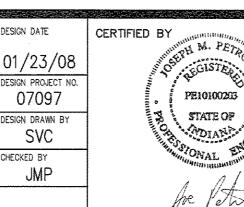

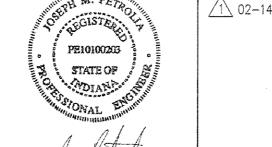


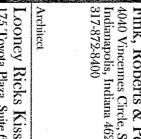


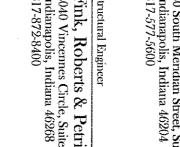

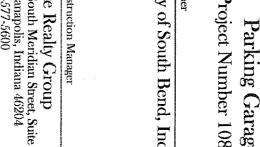




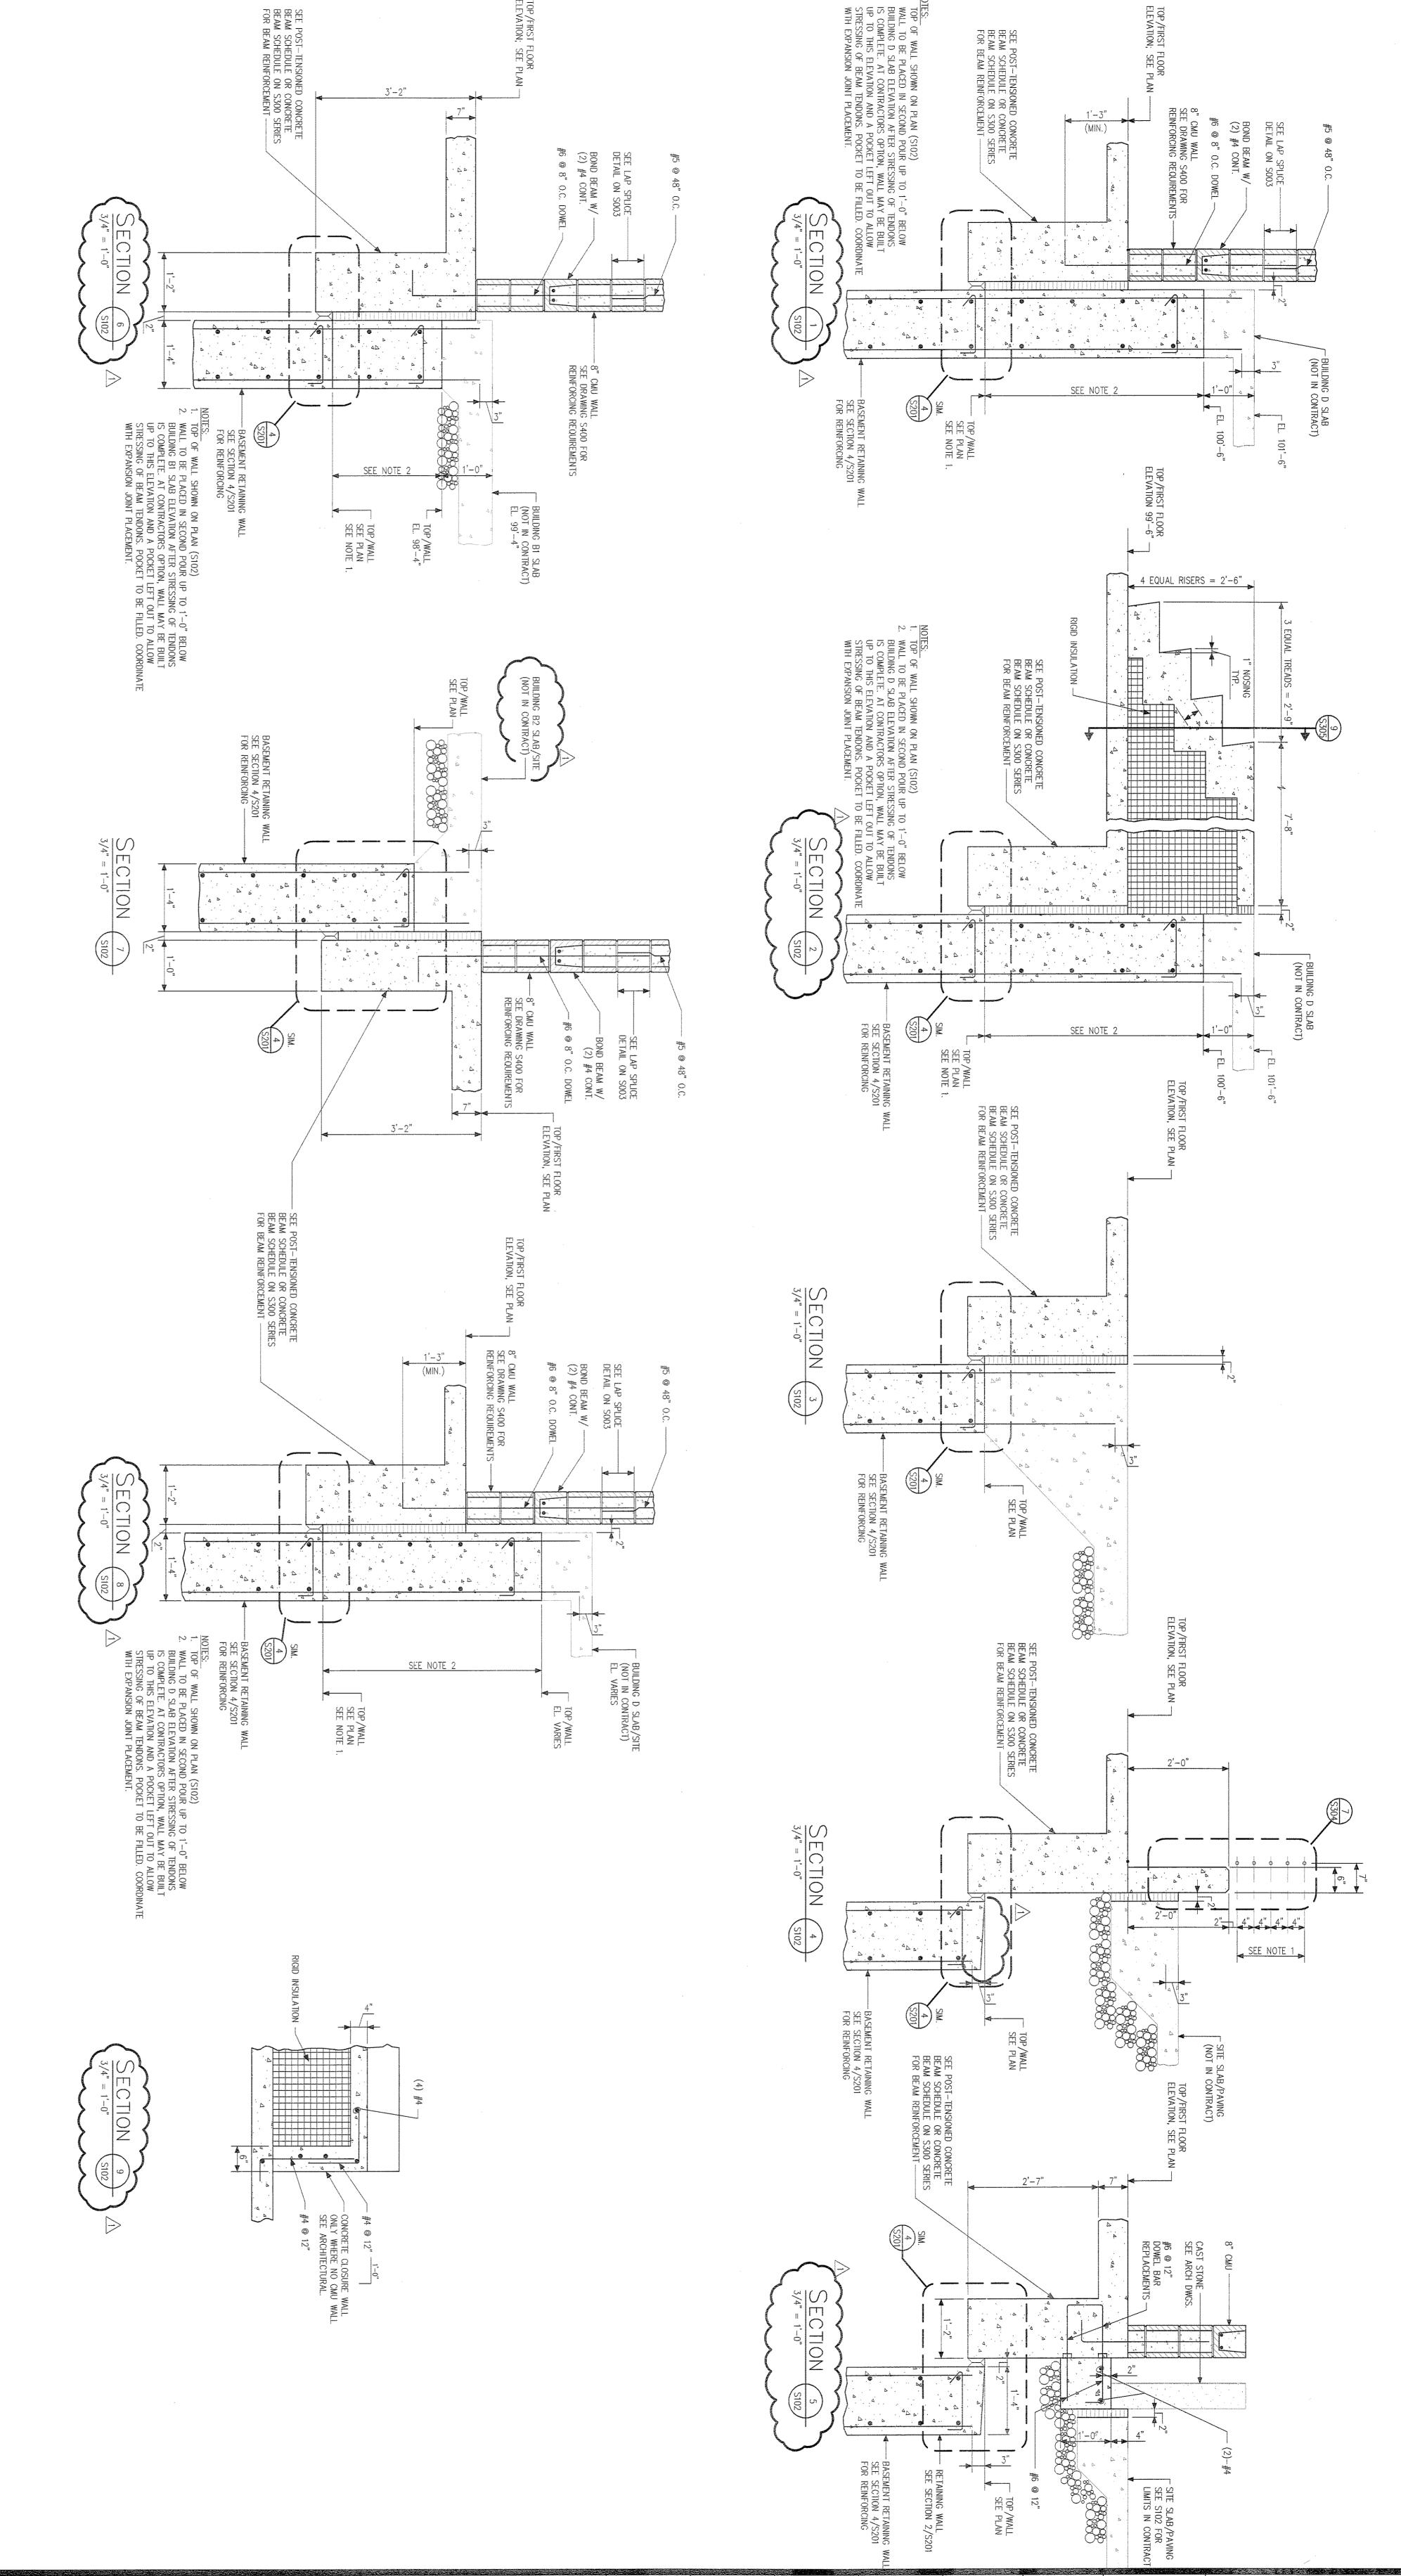


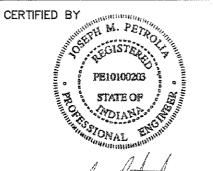


1 02-14-08 ADDENDUM NO. 3

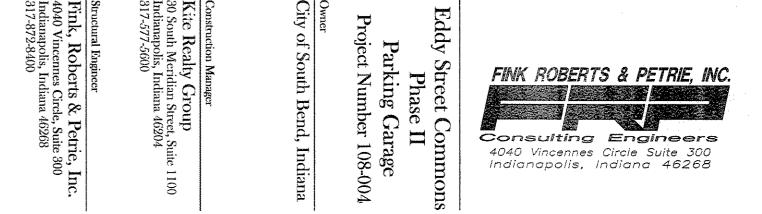

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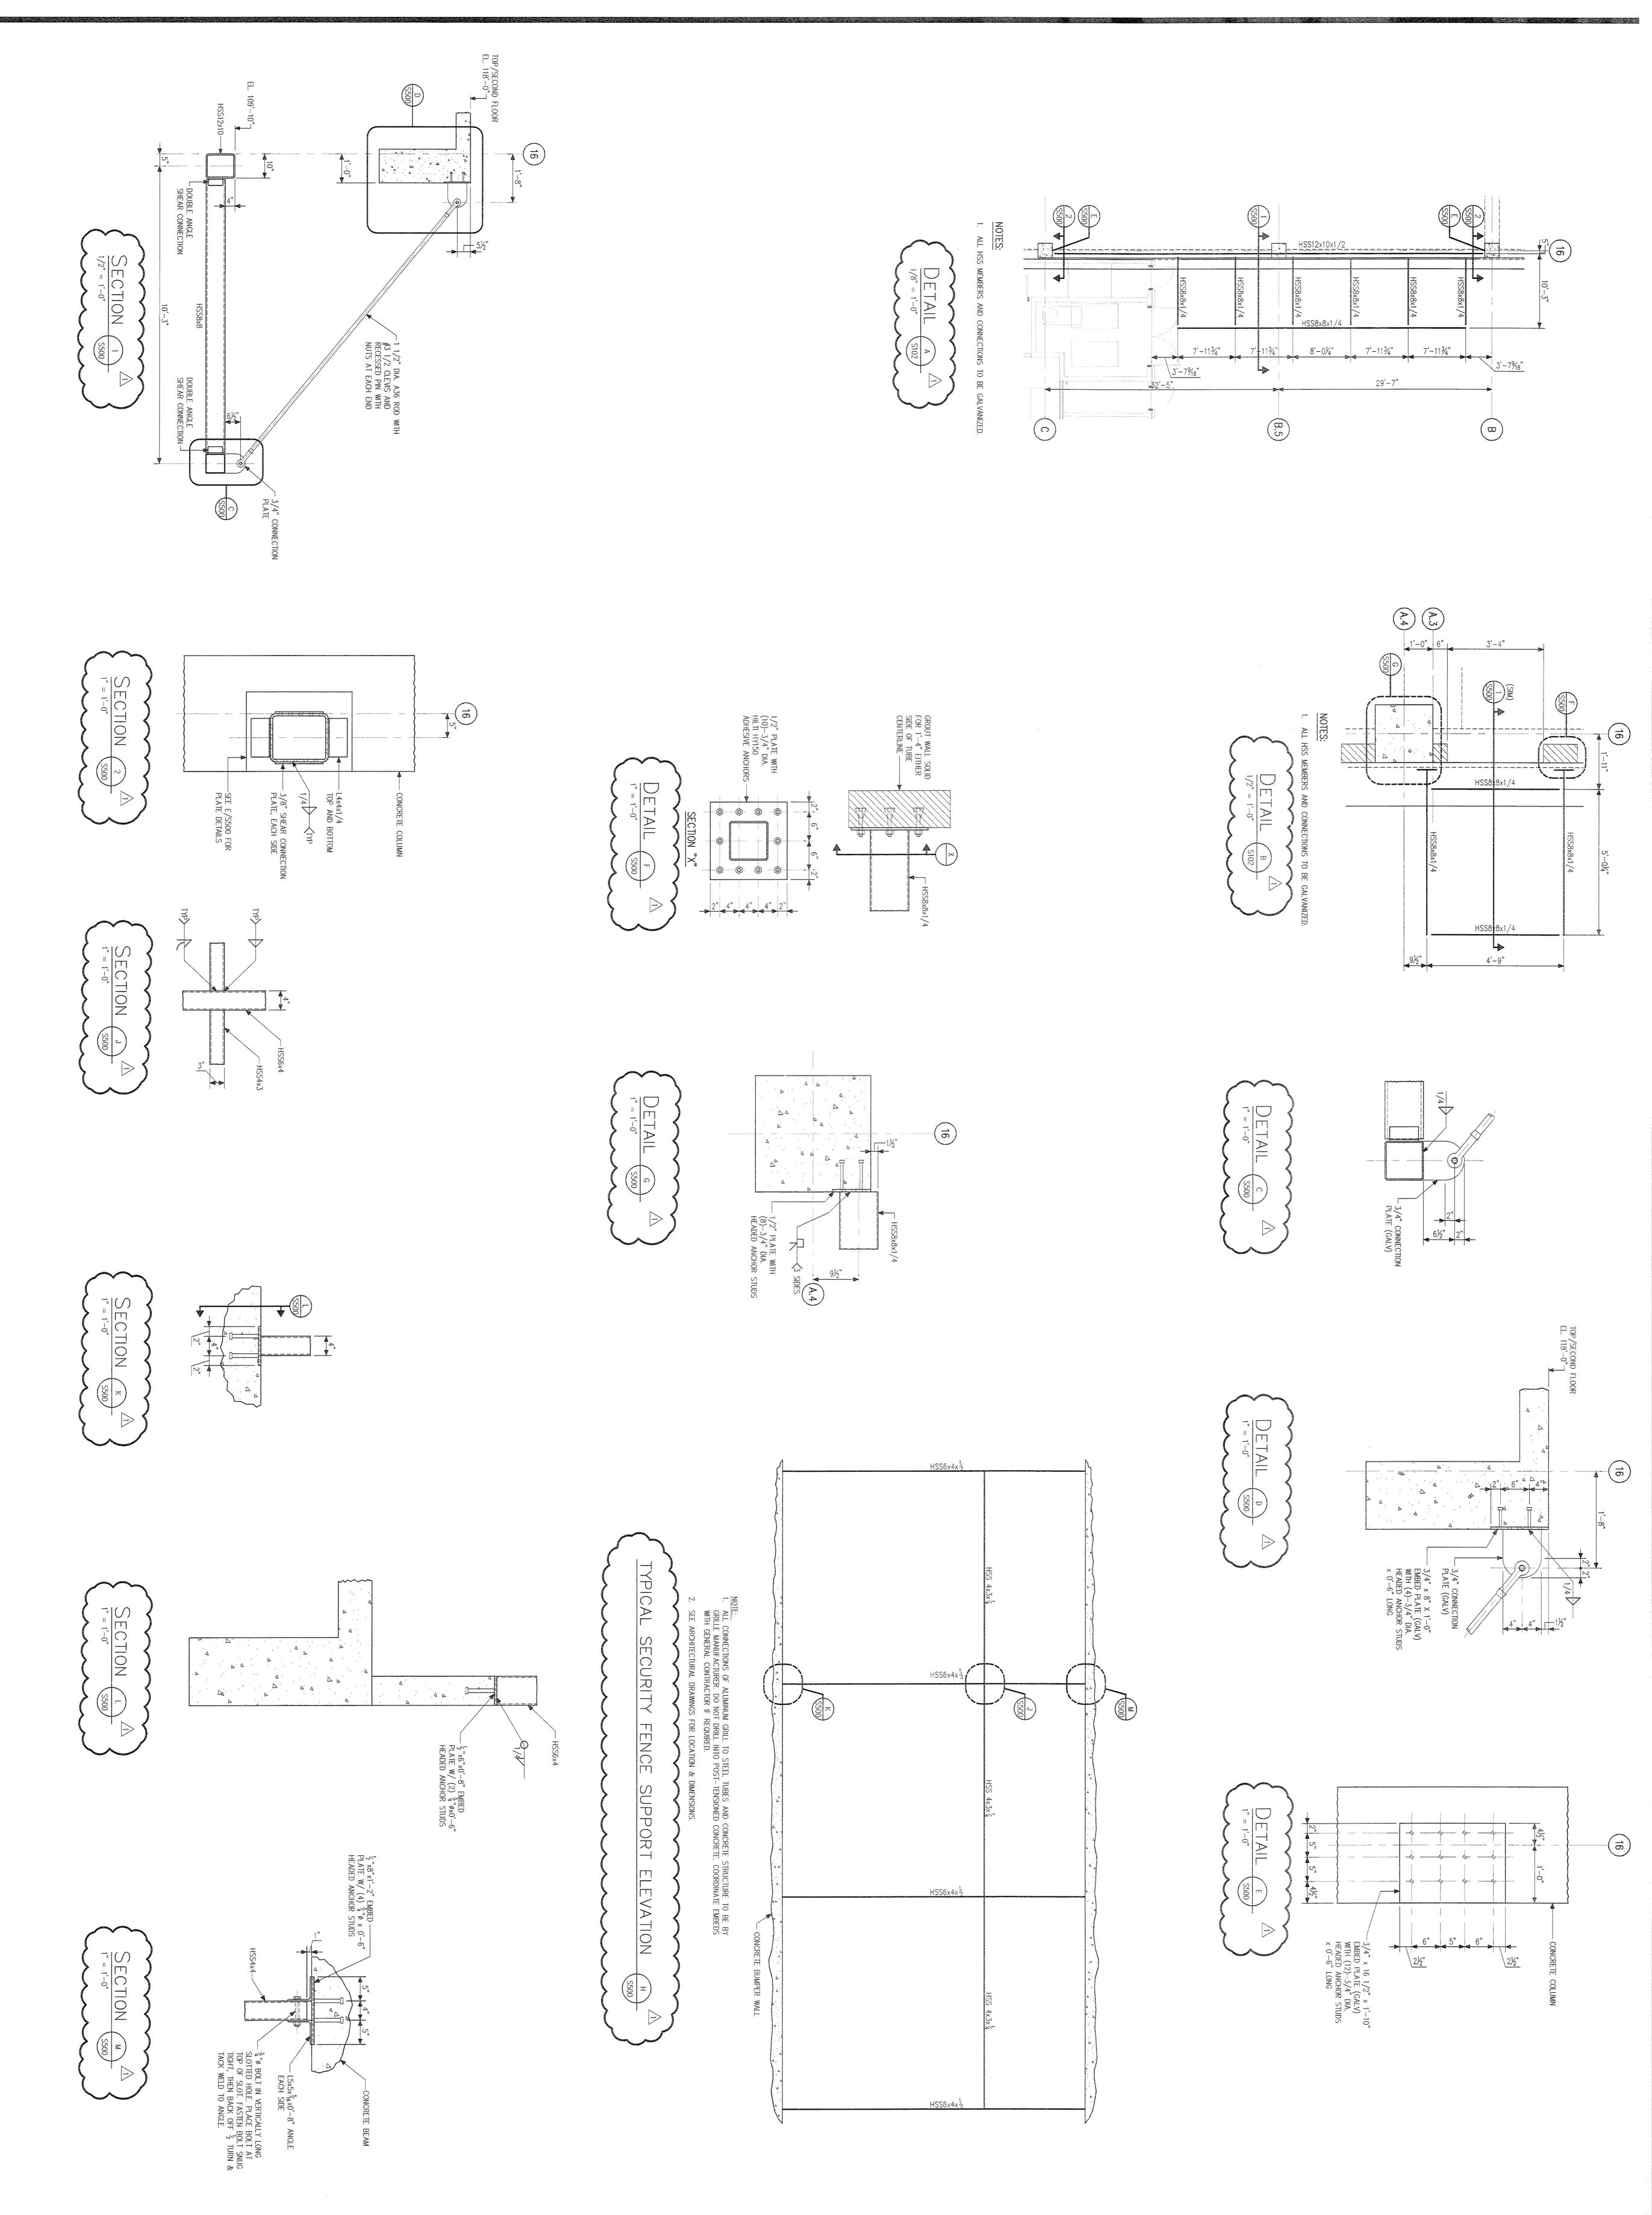

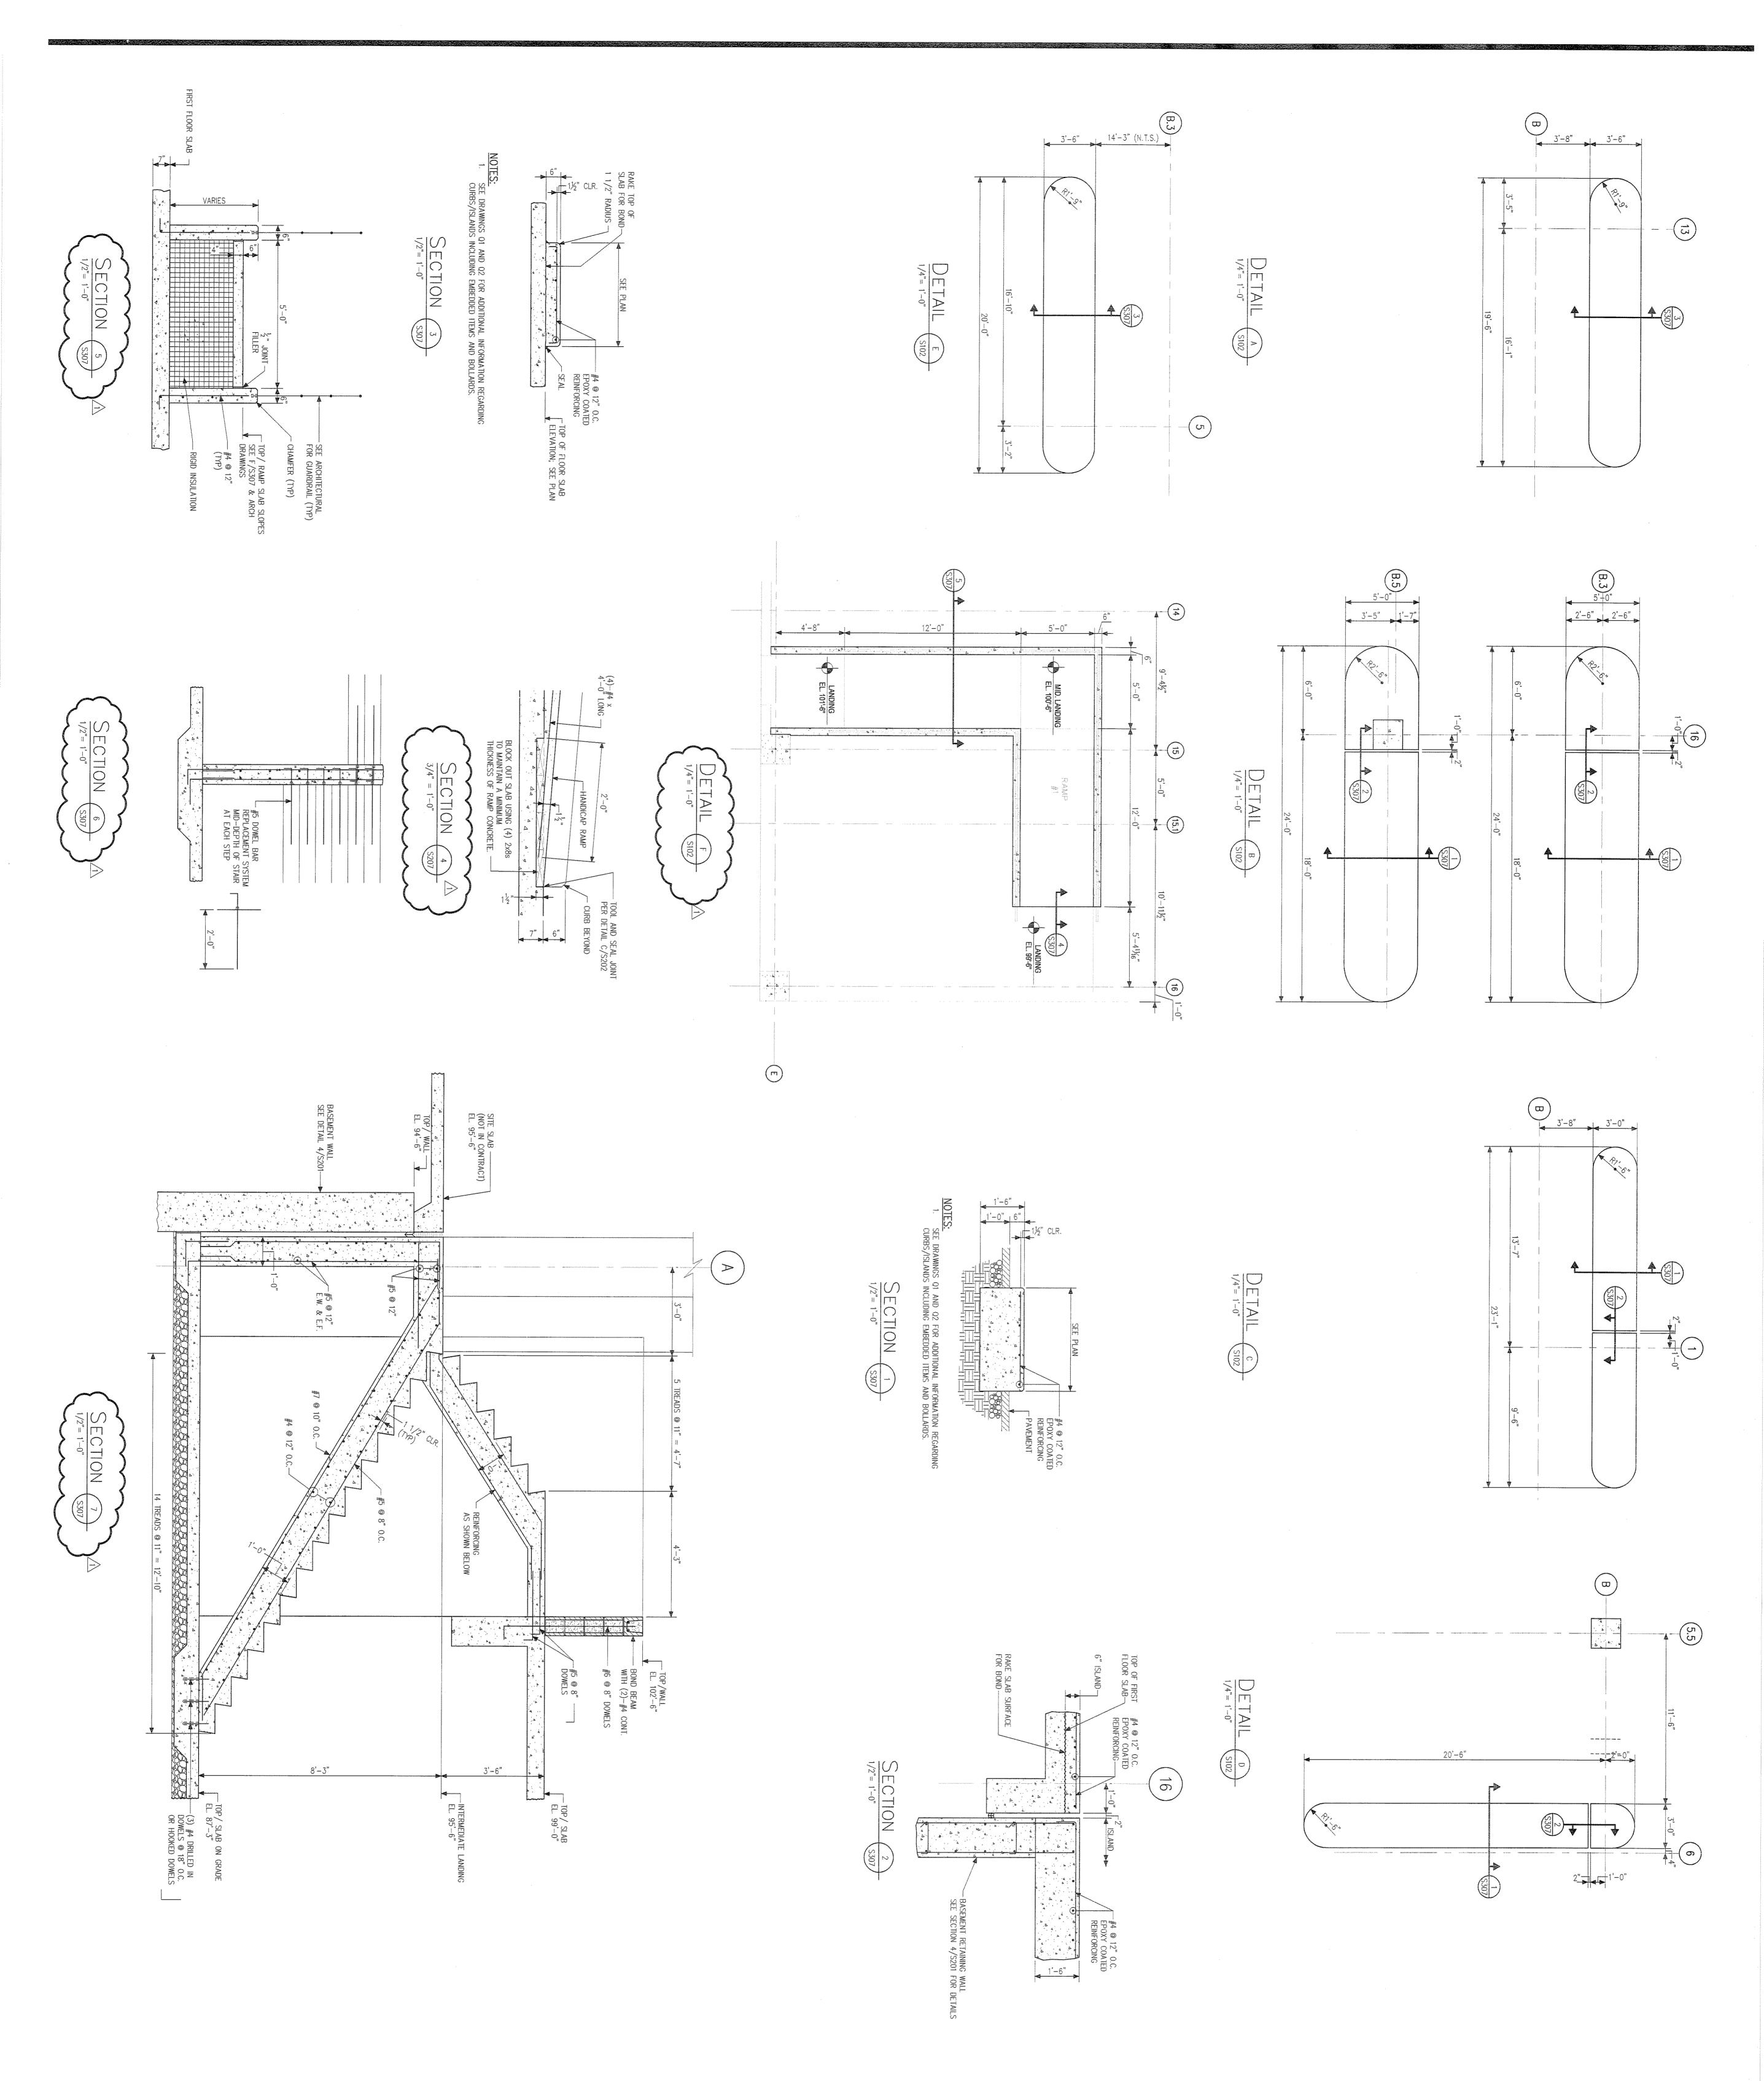
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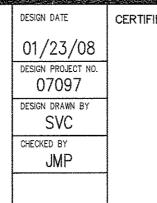
100% Construction
Documents
January 23, 2008



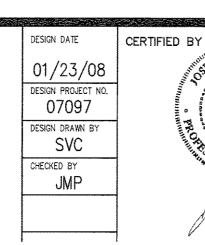


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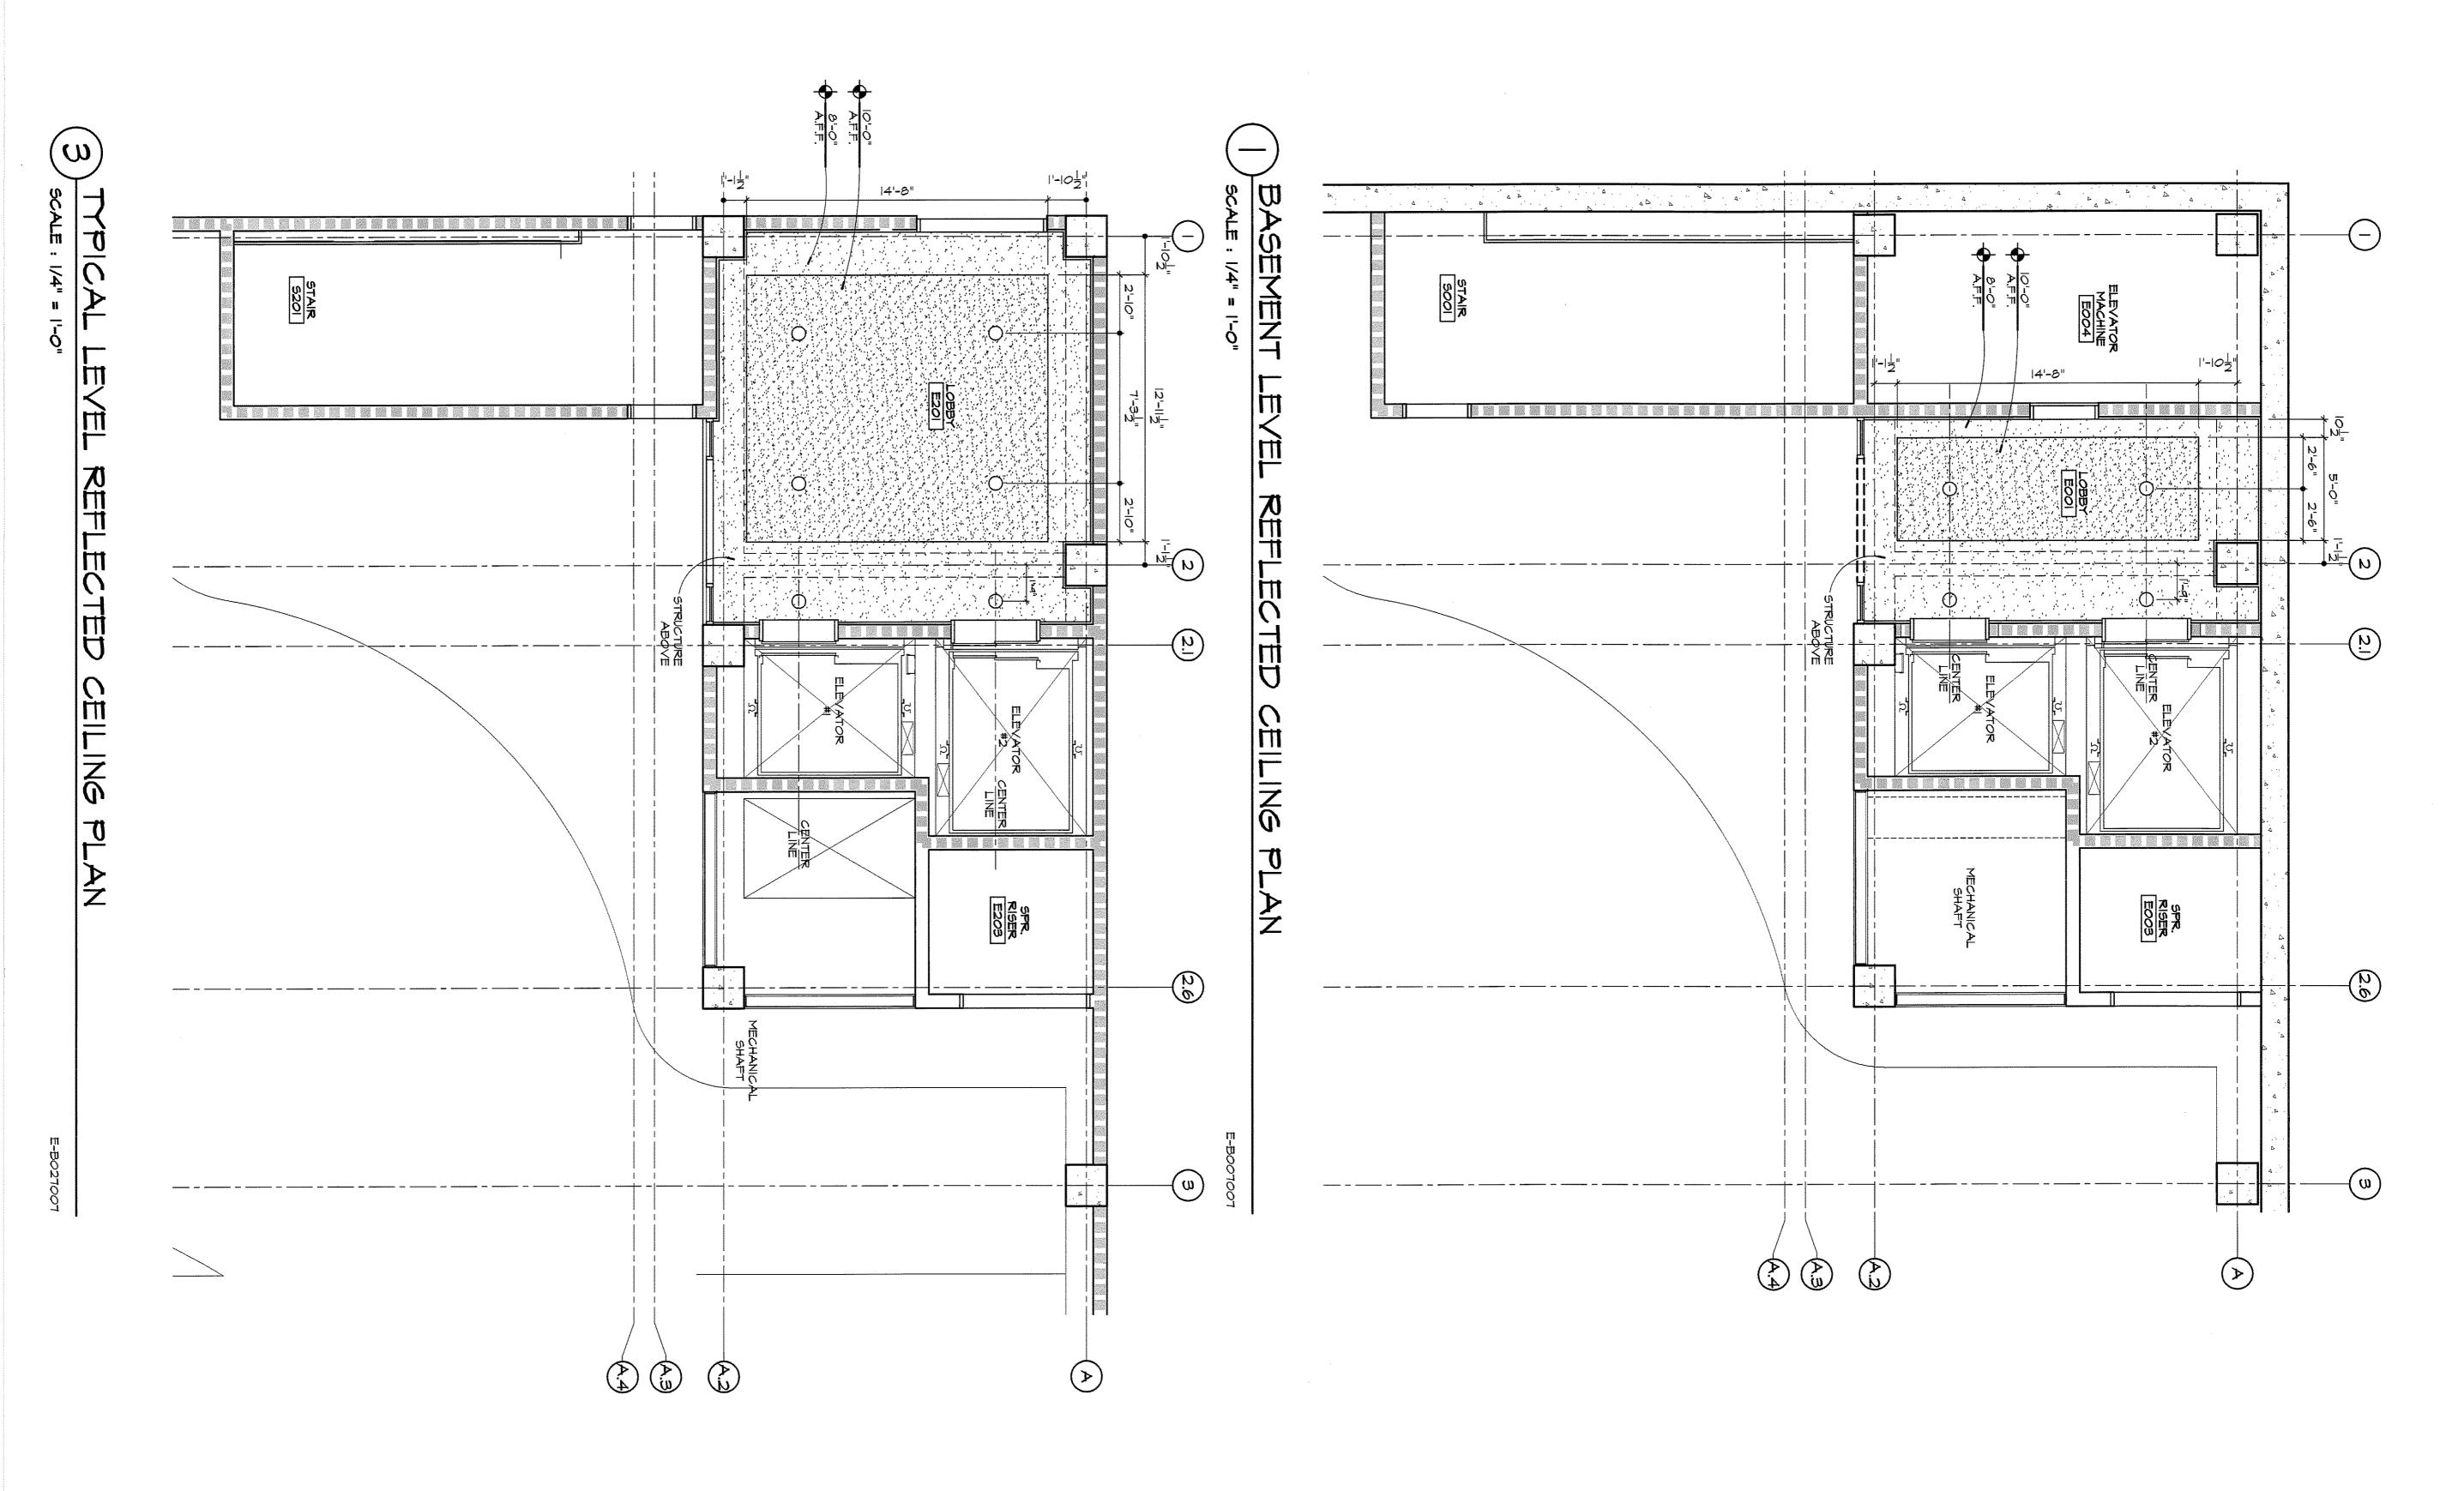









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January 23, 2008

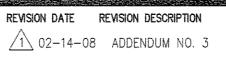City of South Bend, Indiana



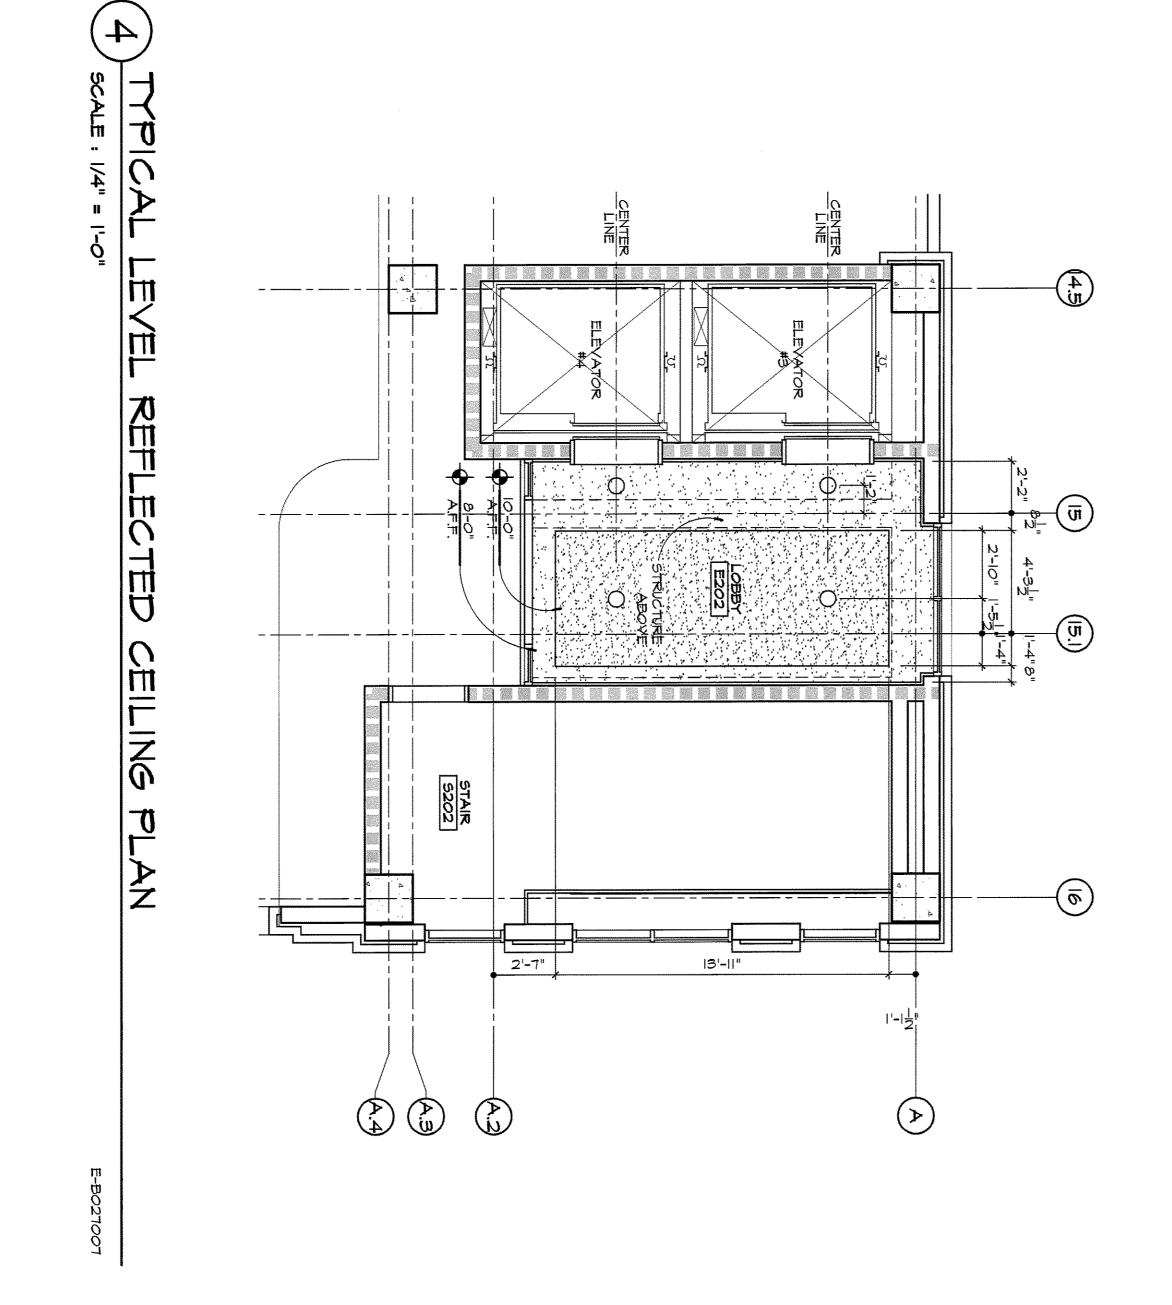


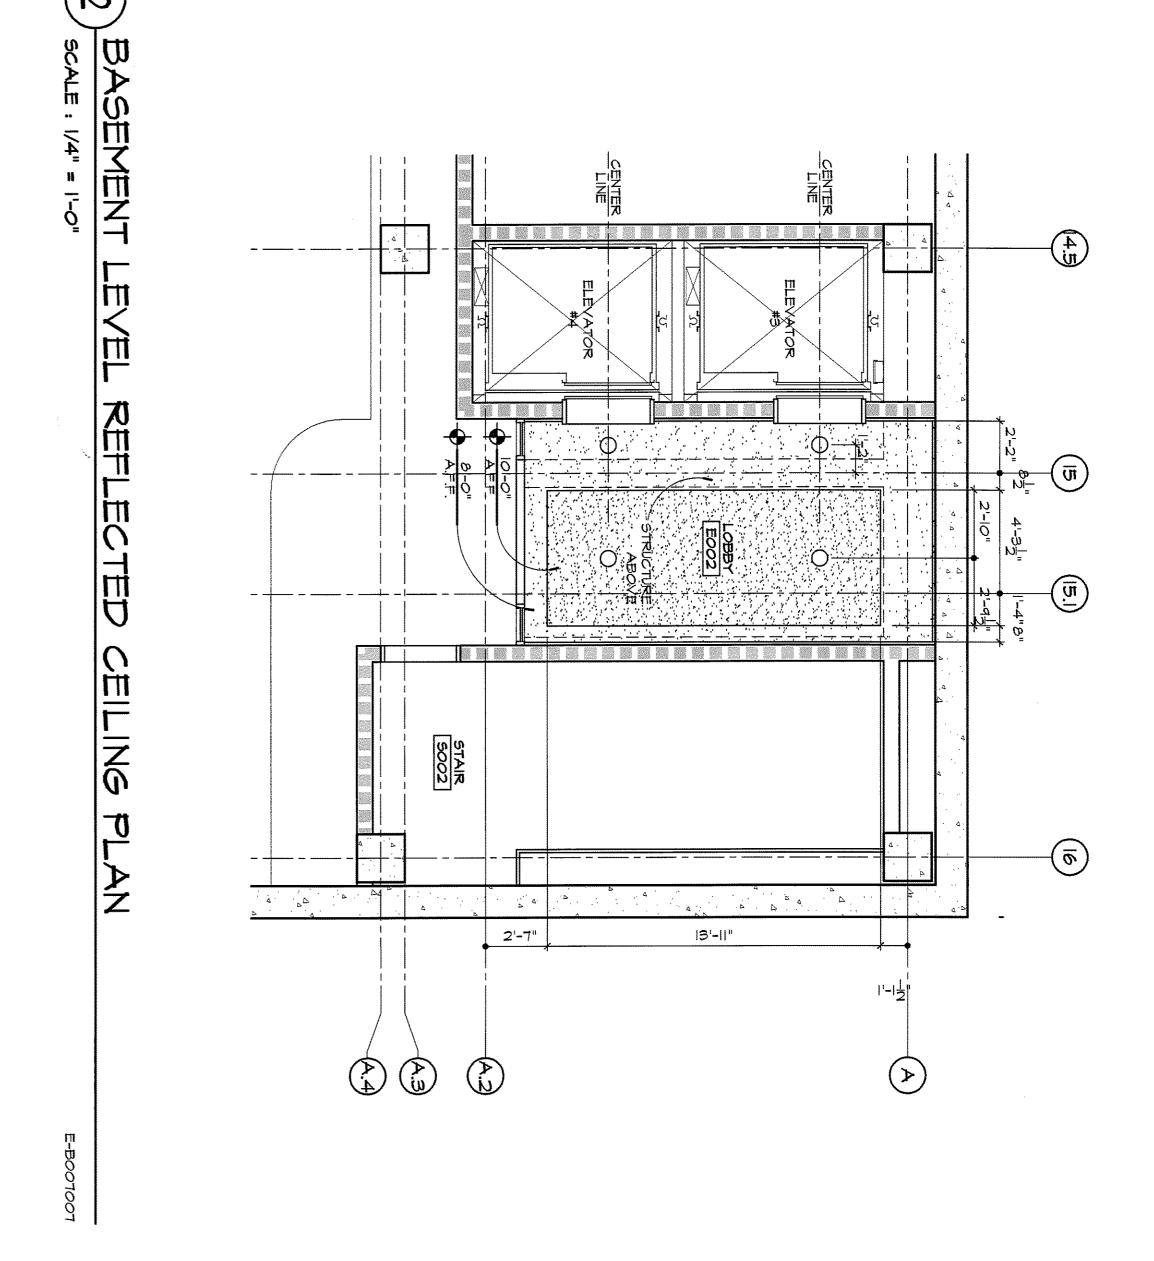


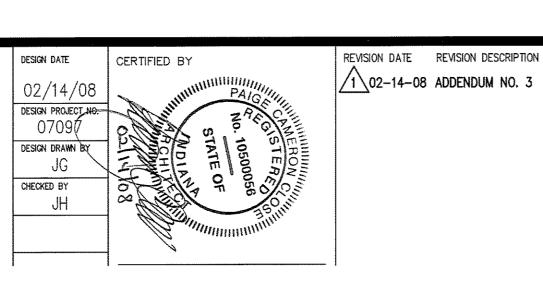



REVISION DATE REVISION DESCRIPTION



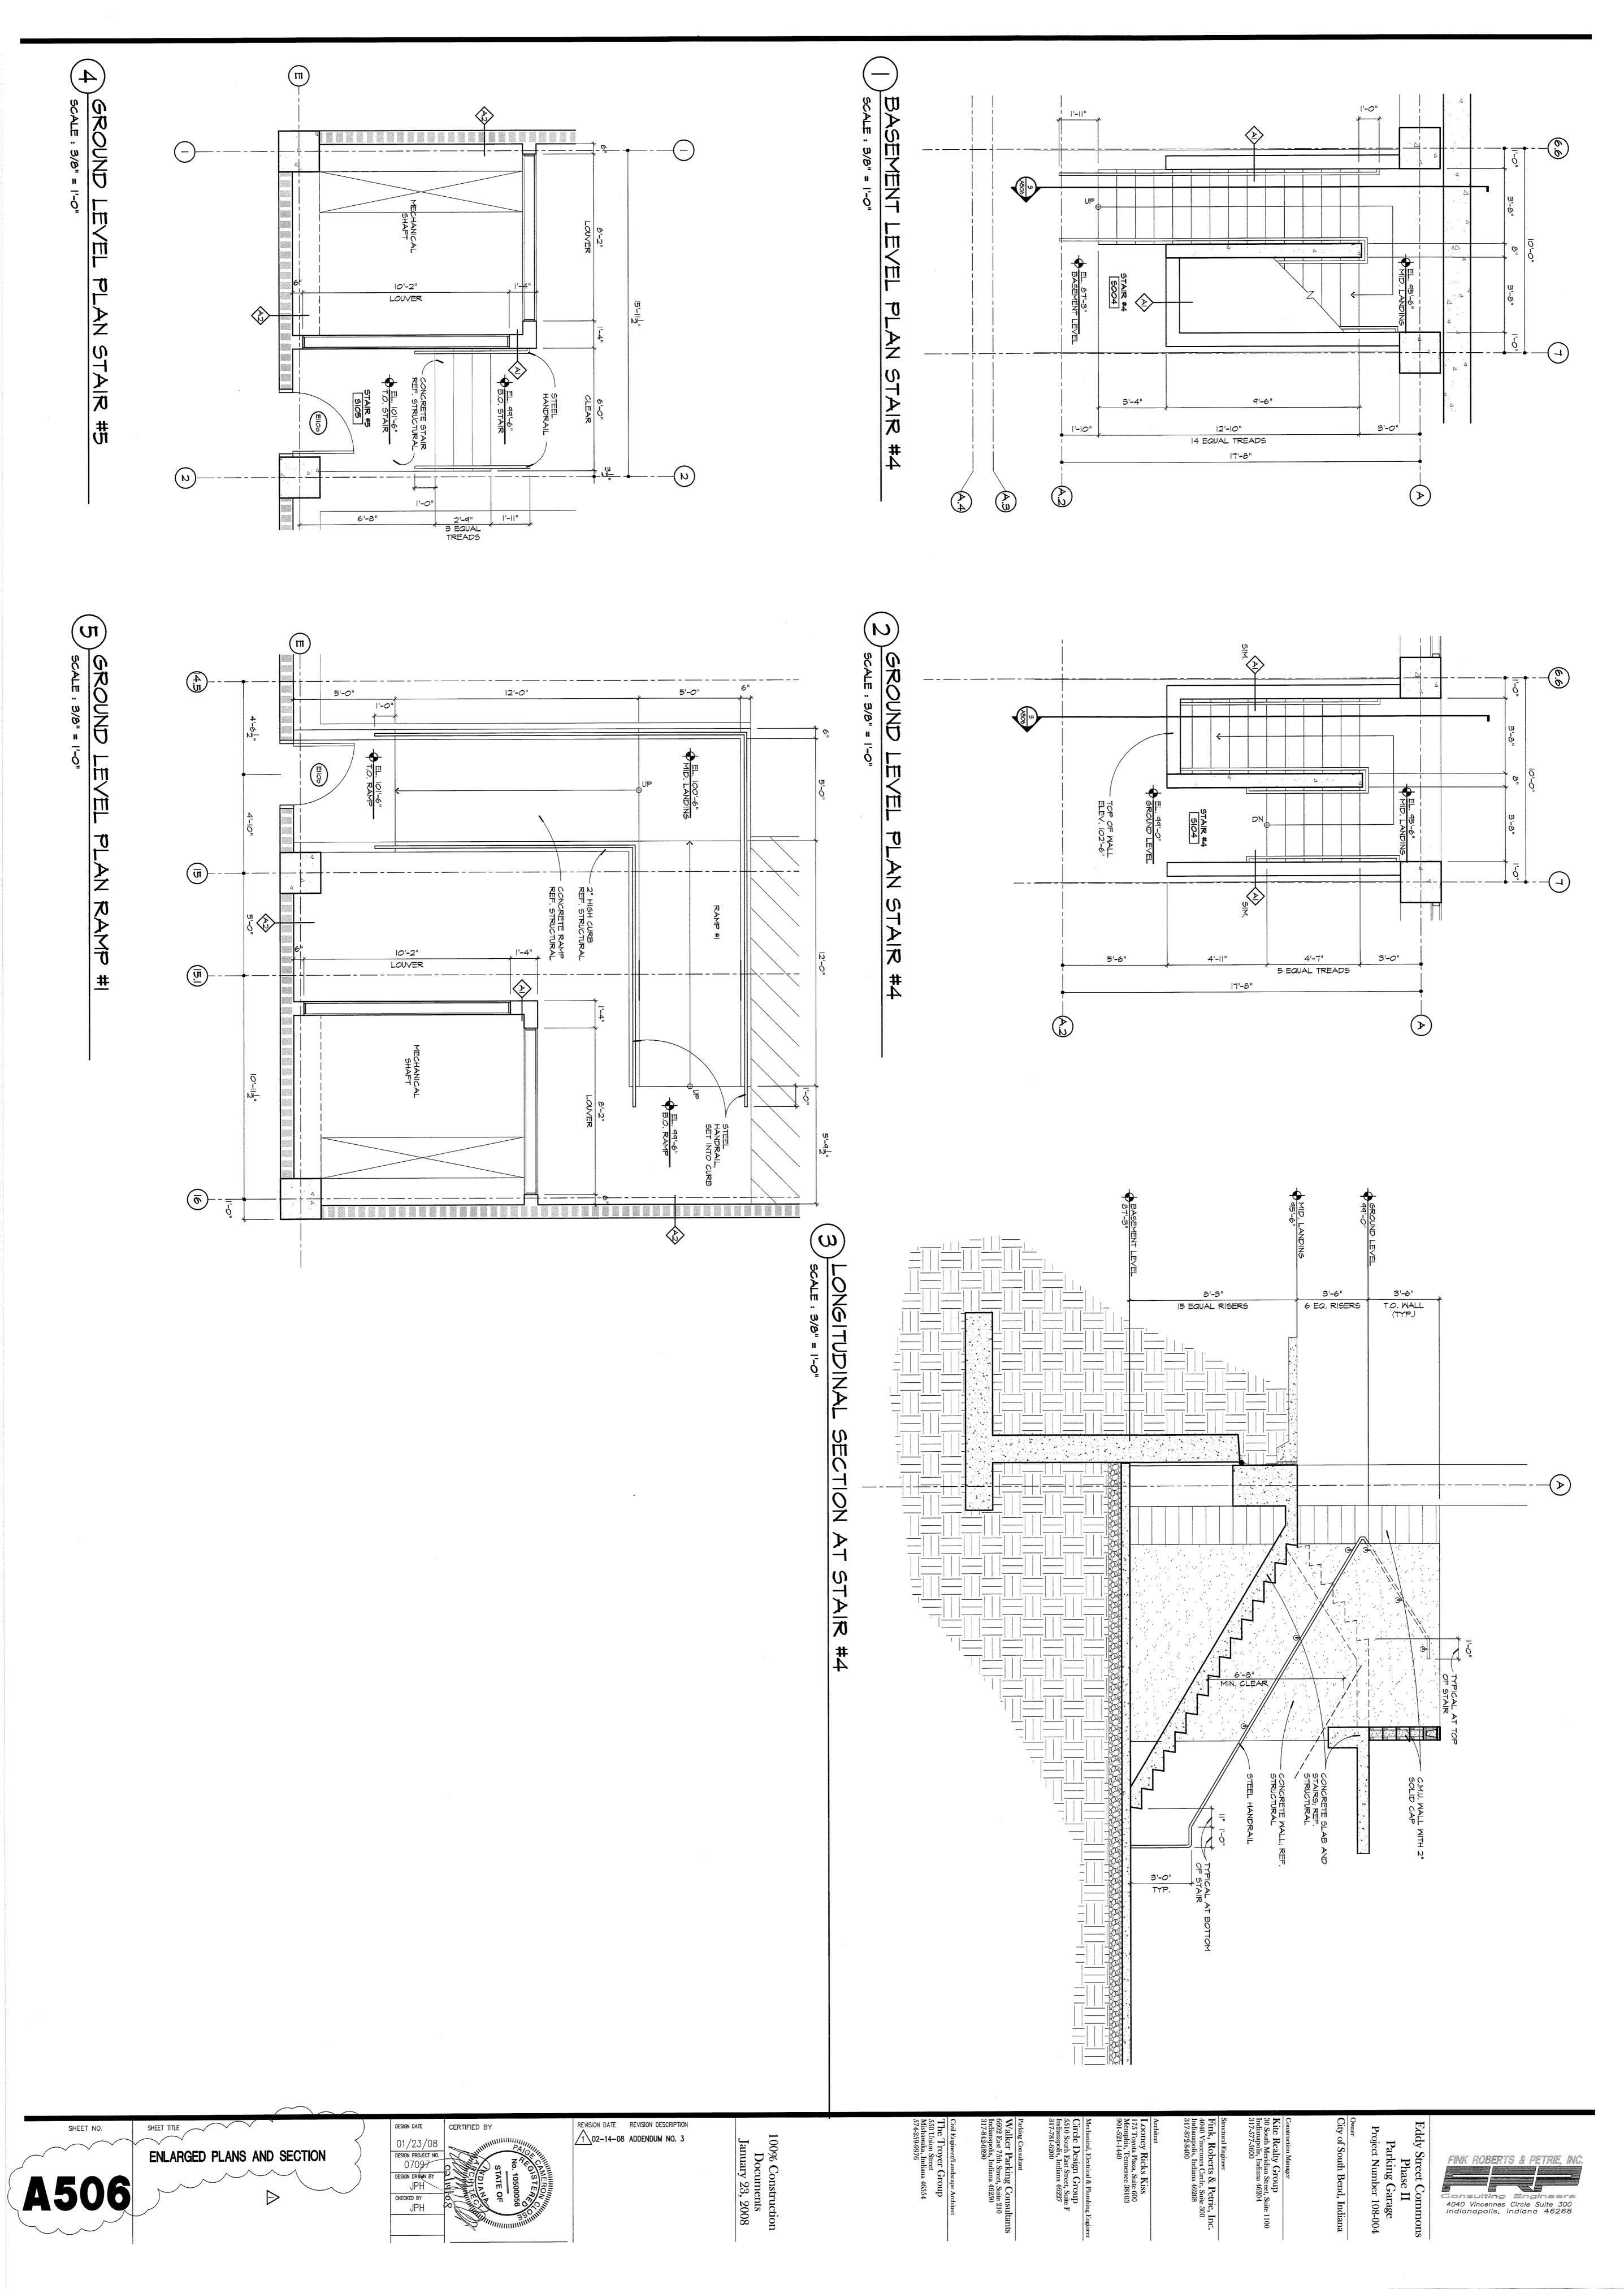


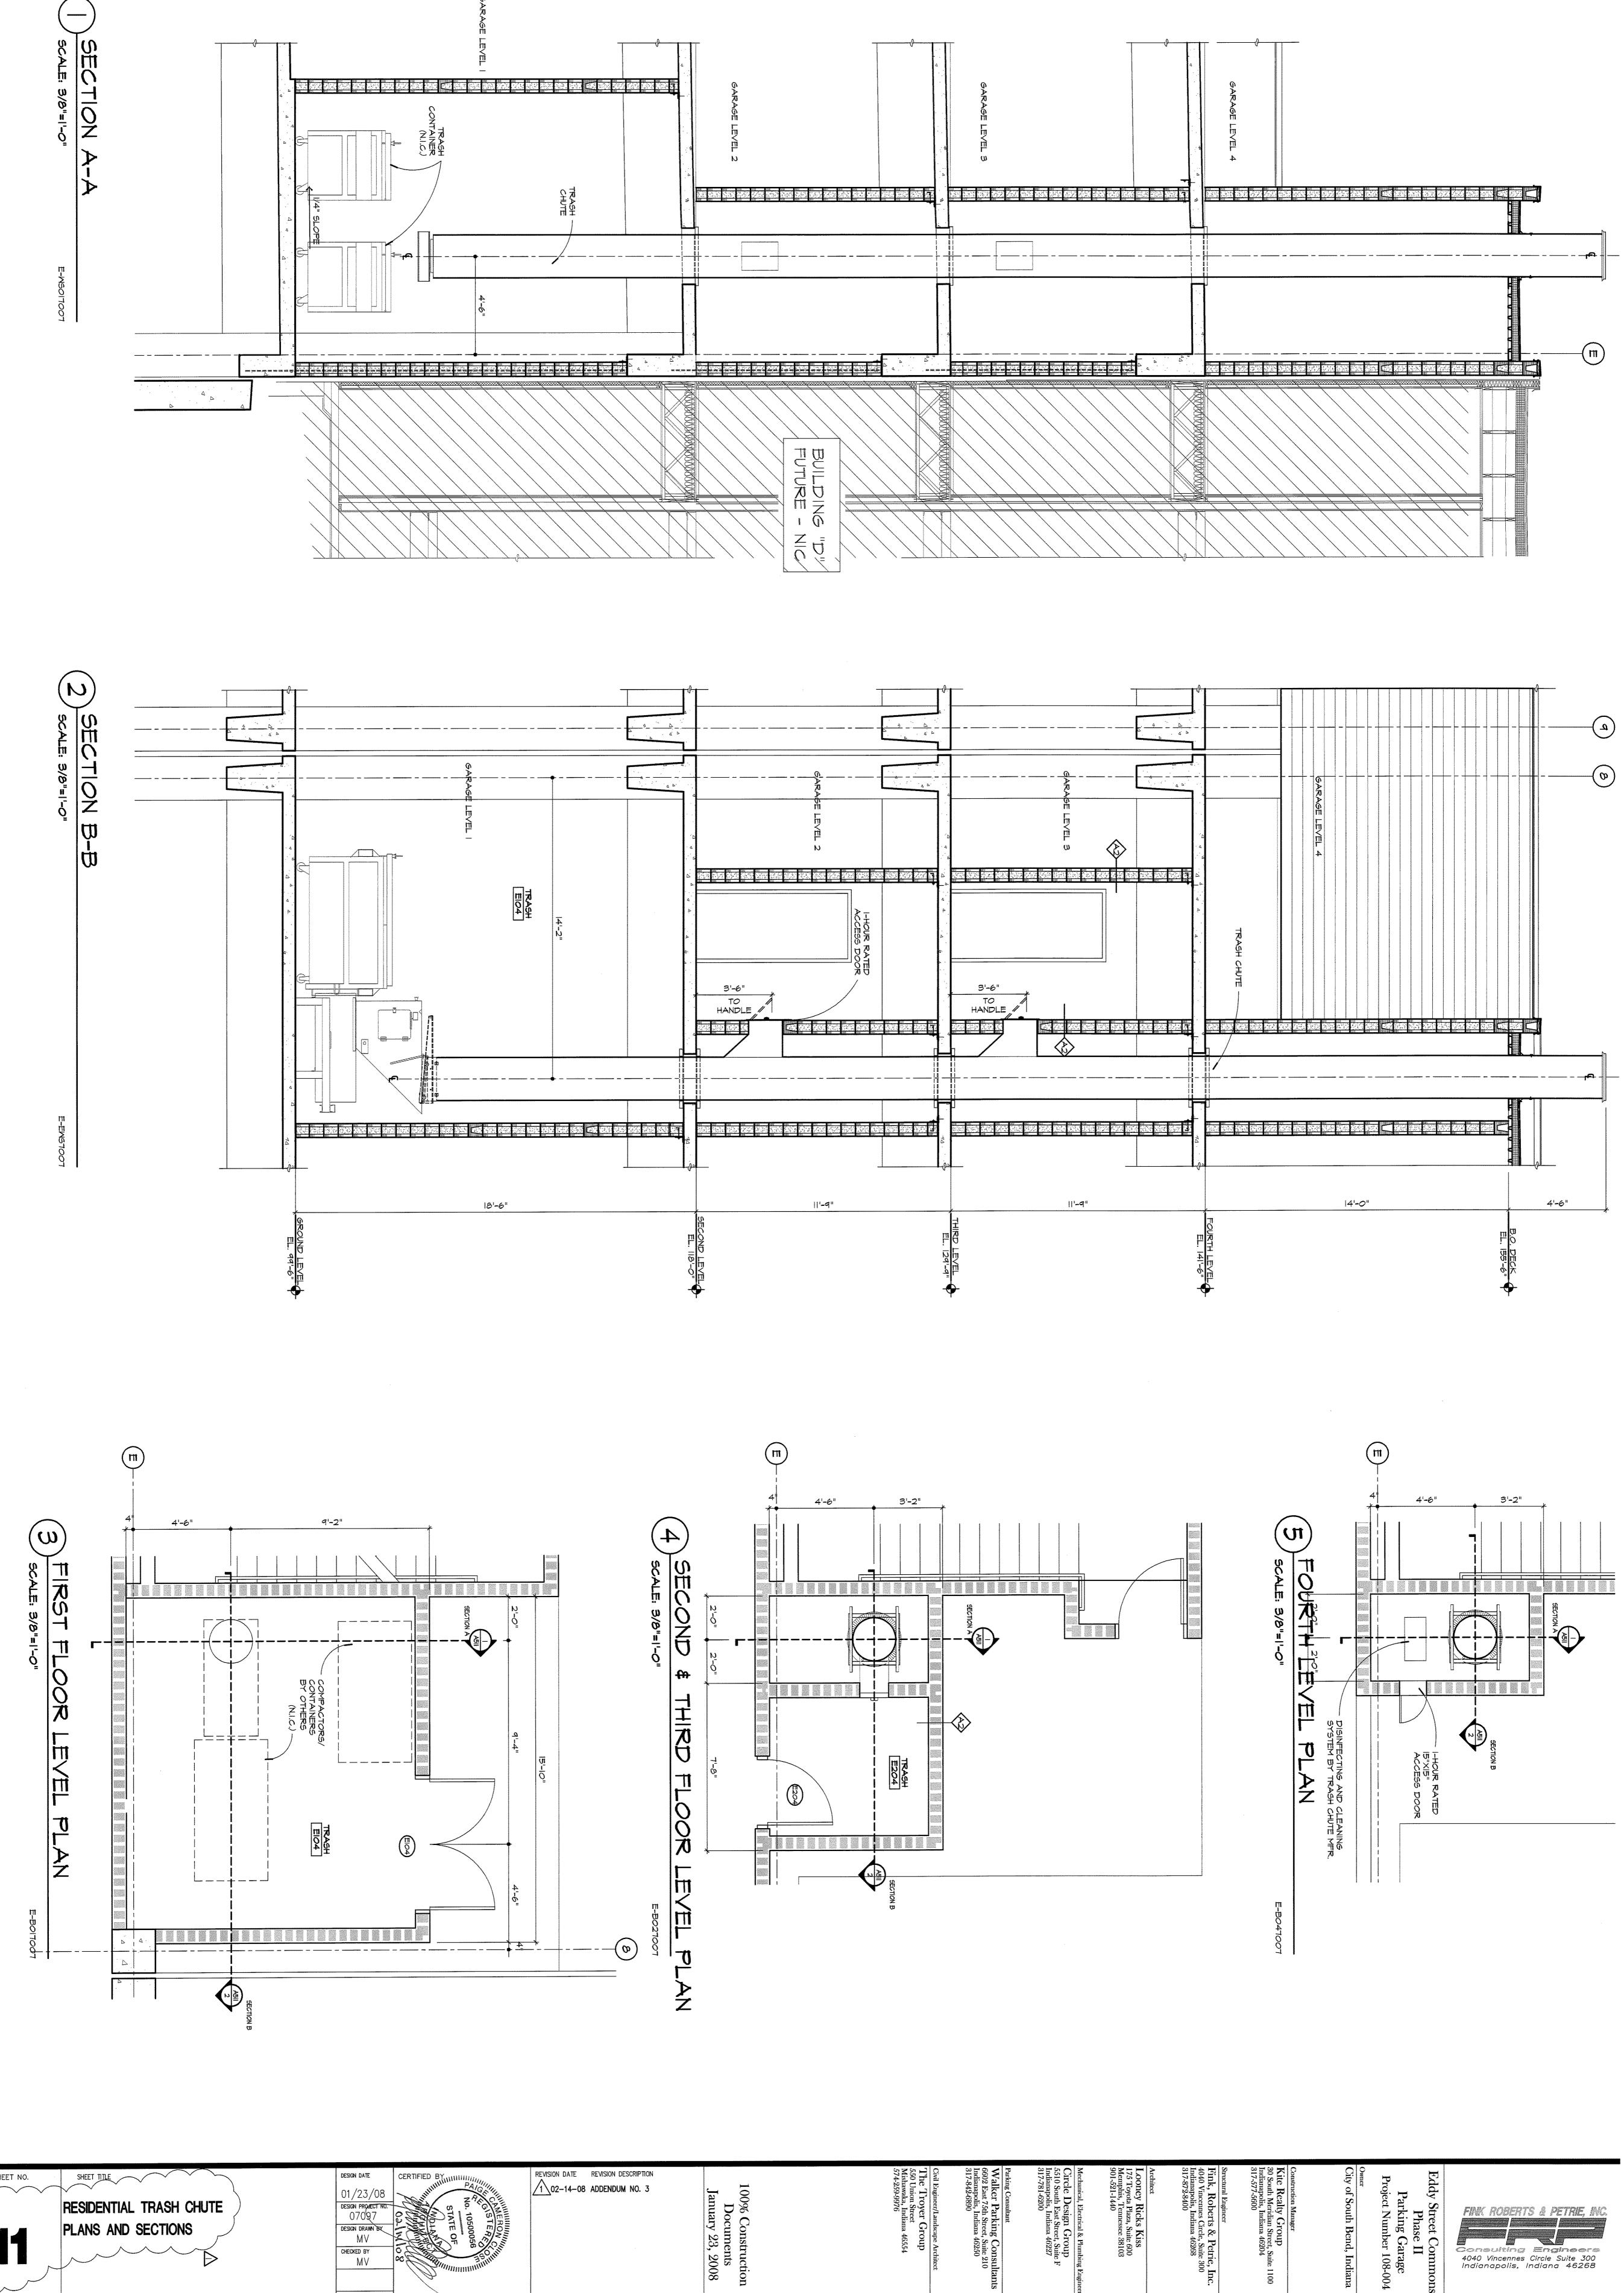


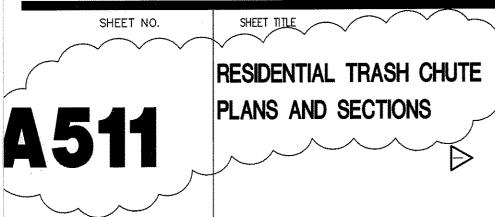

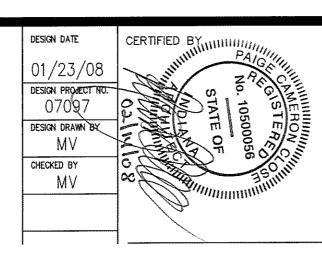



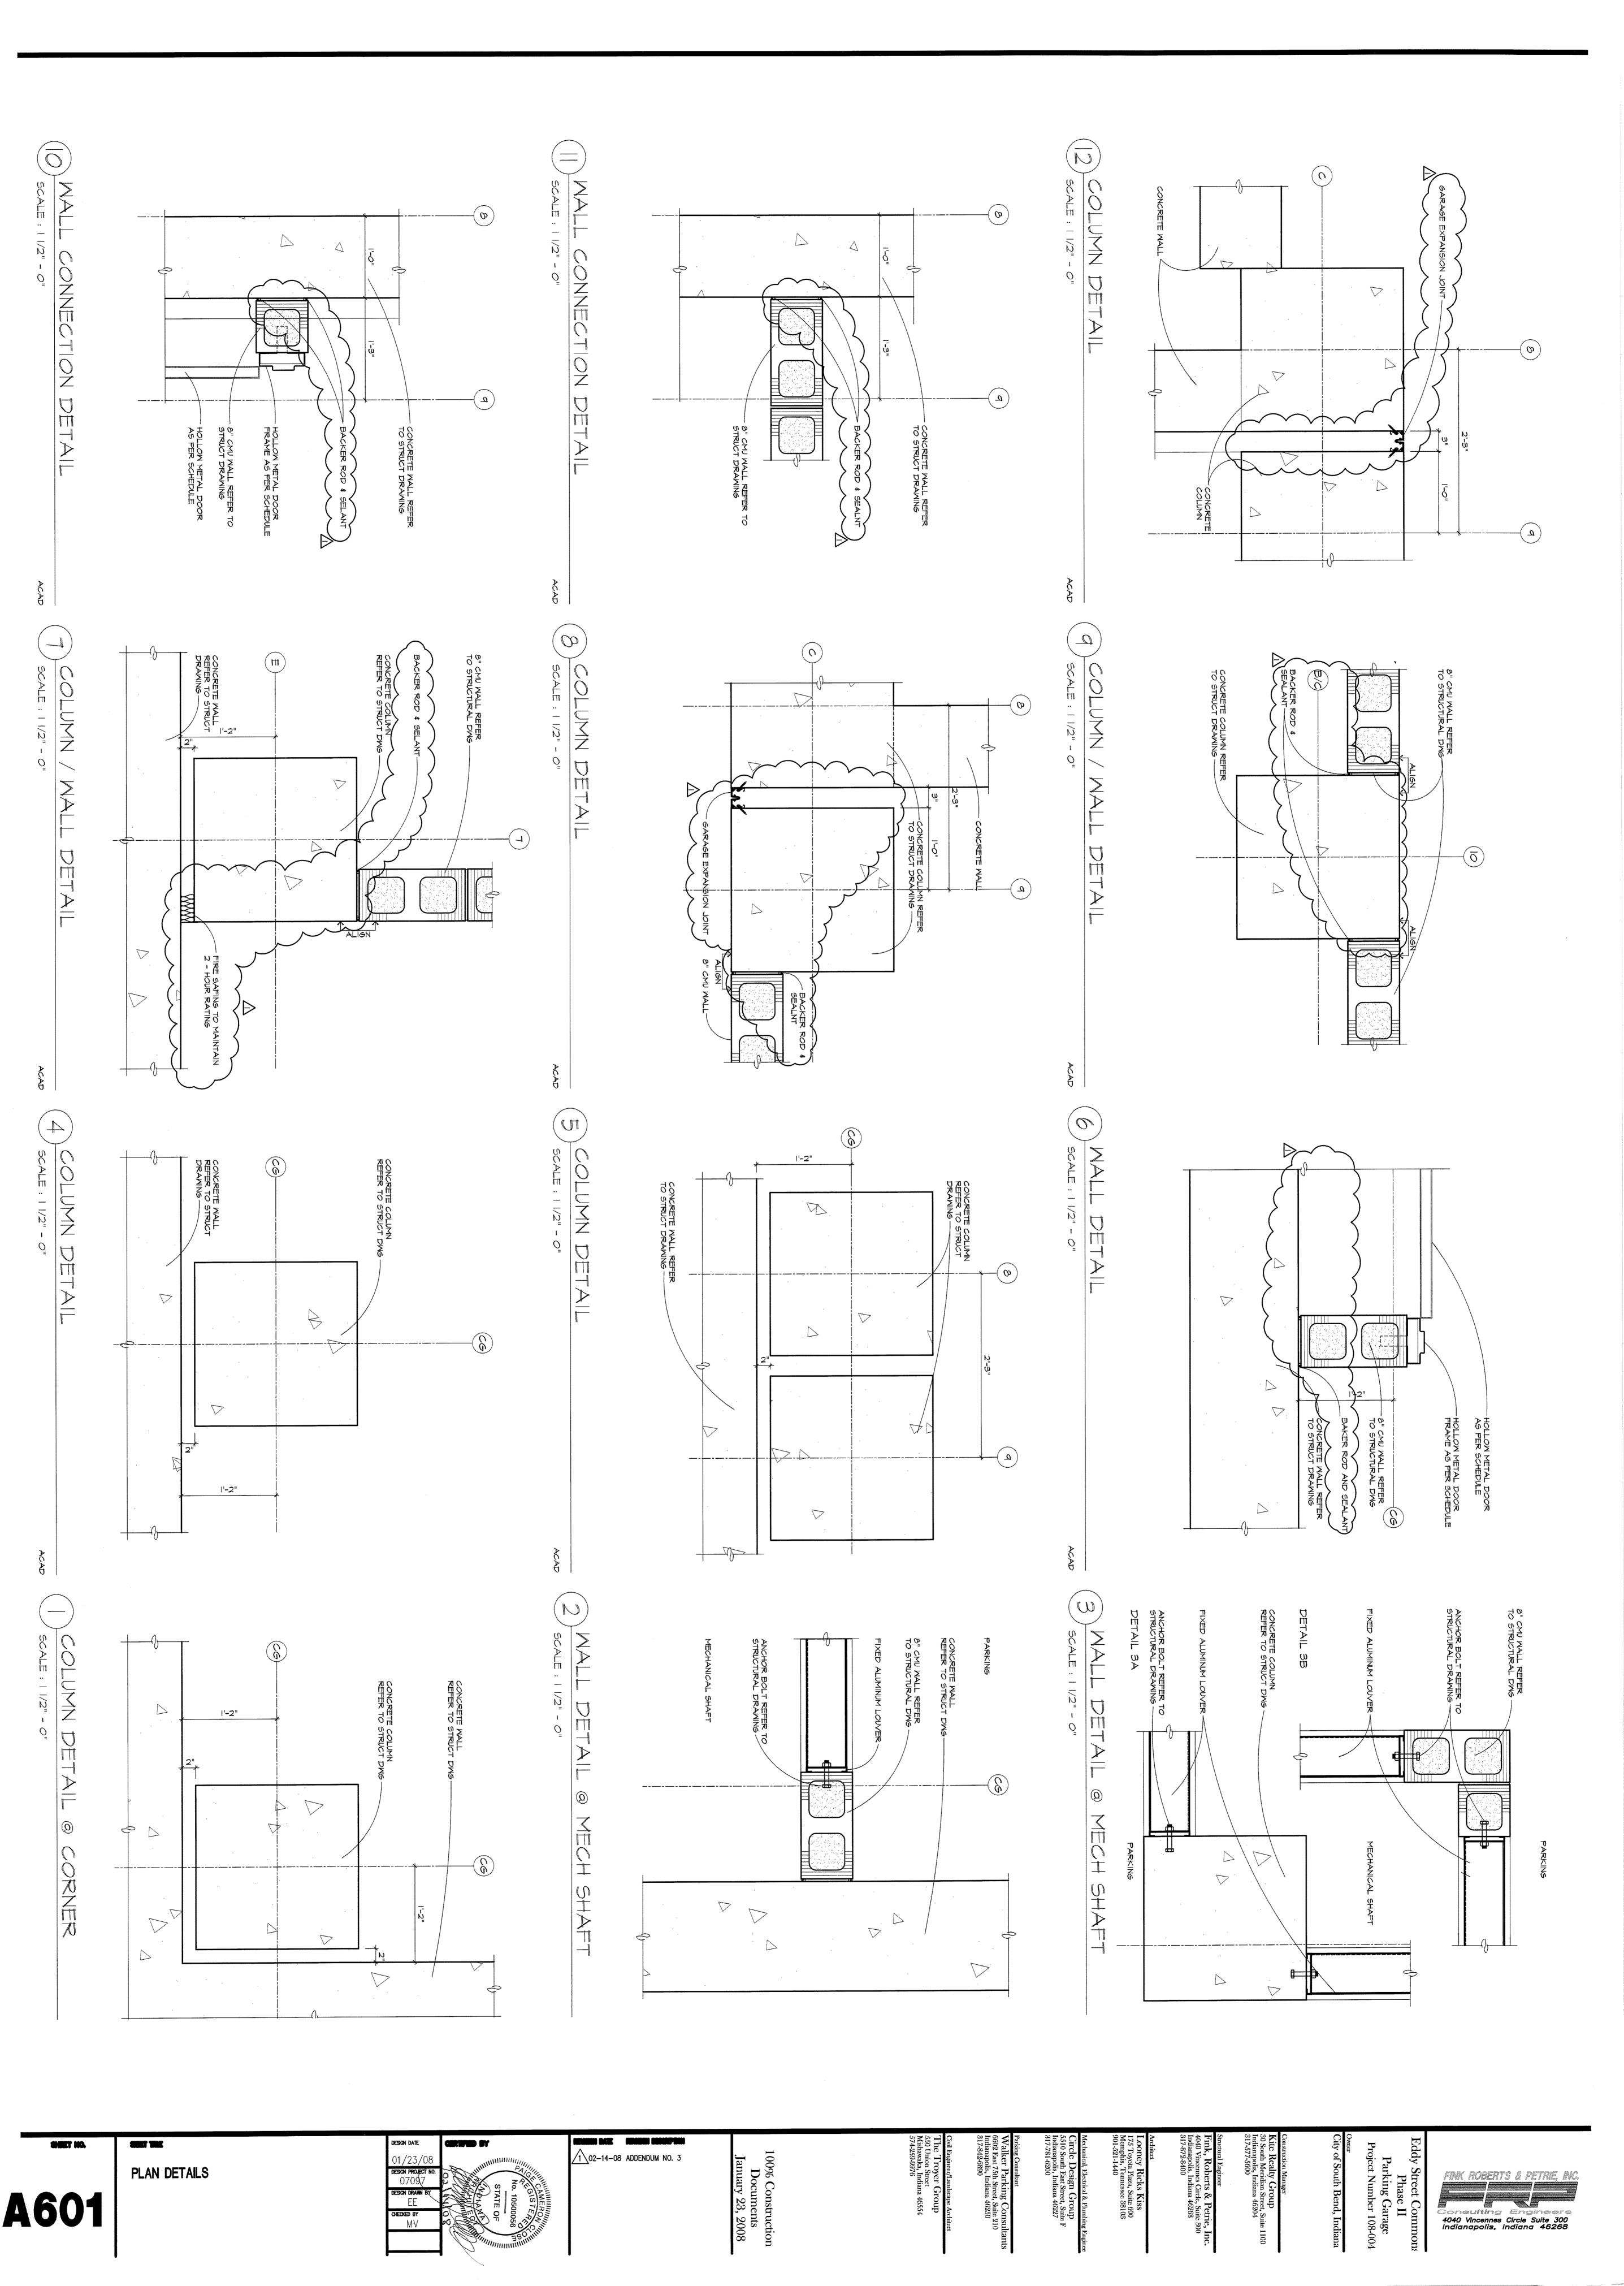

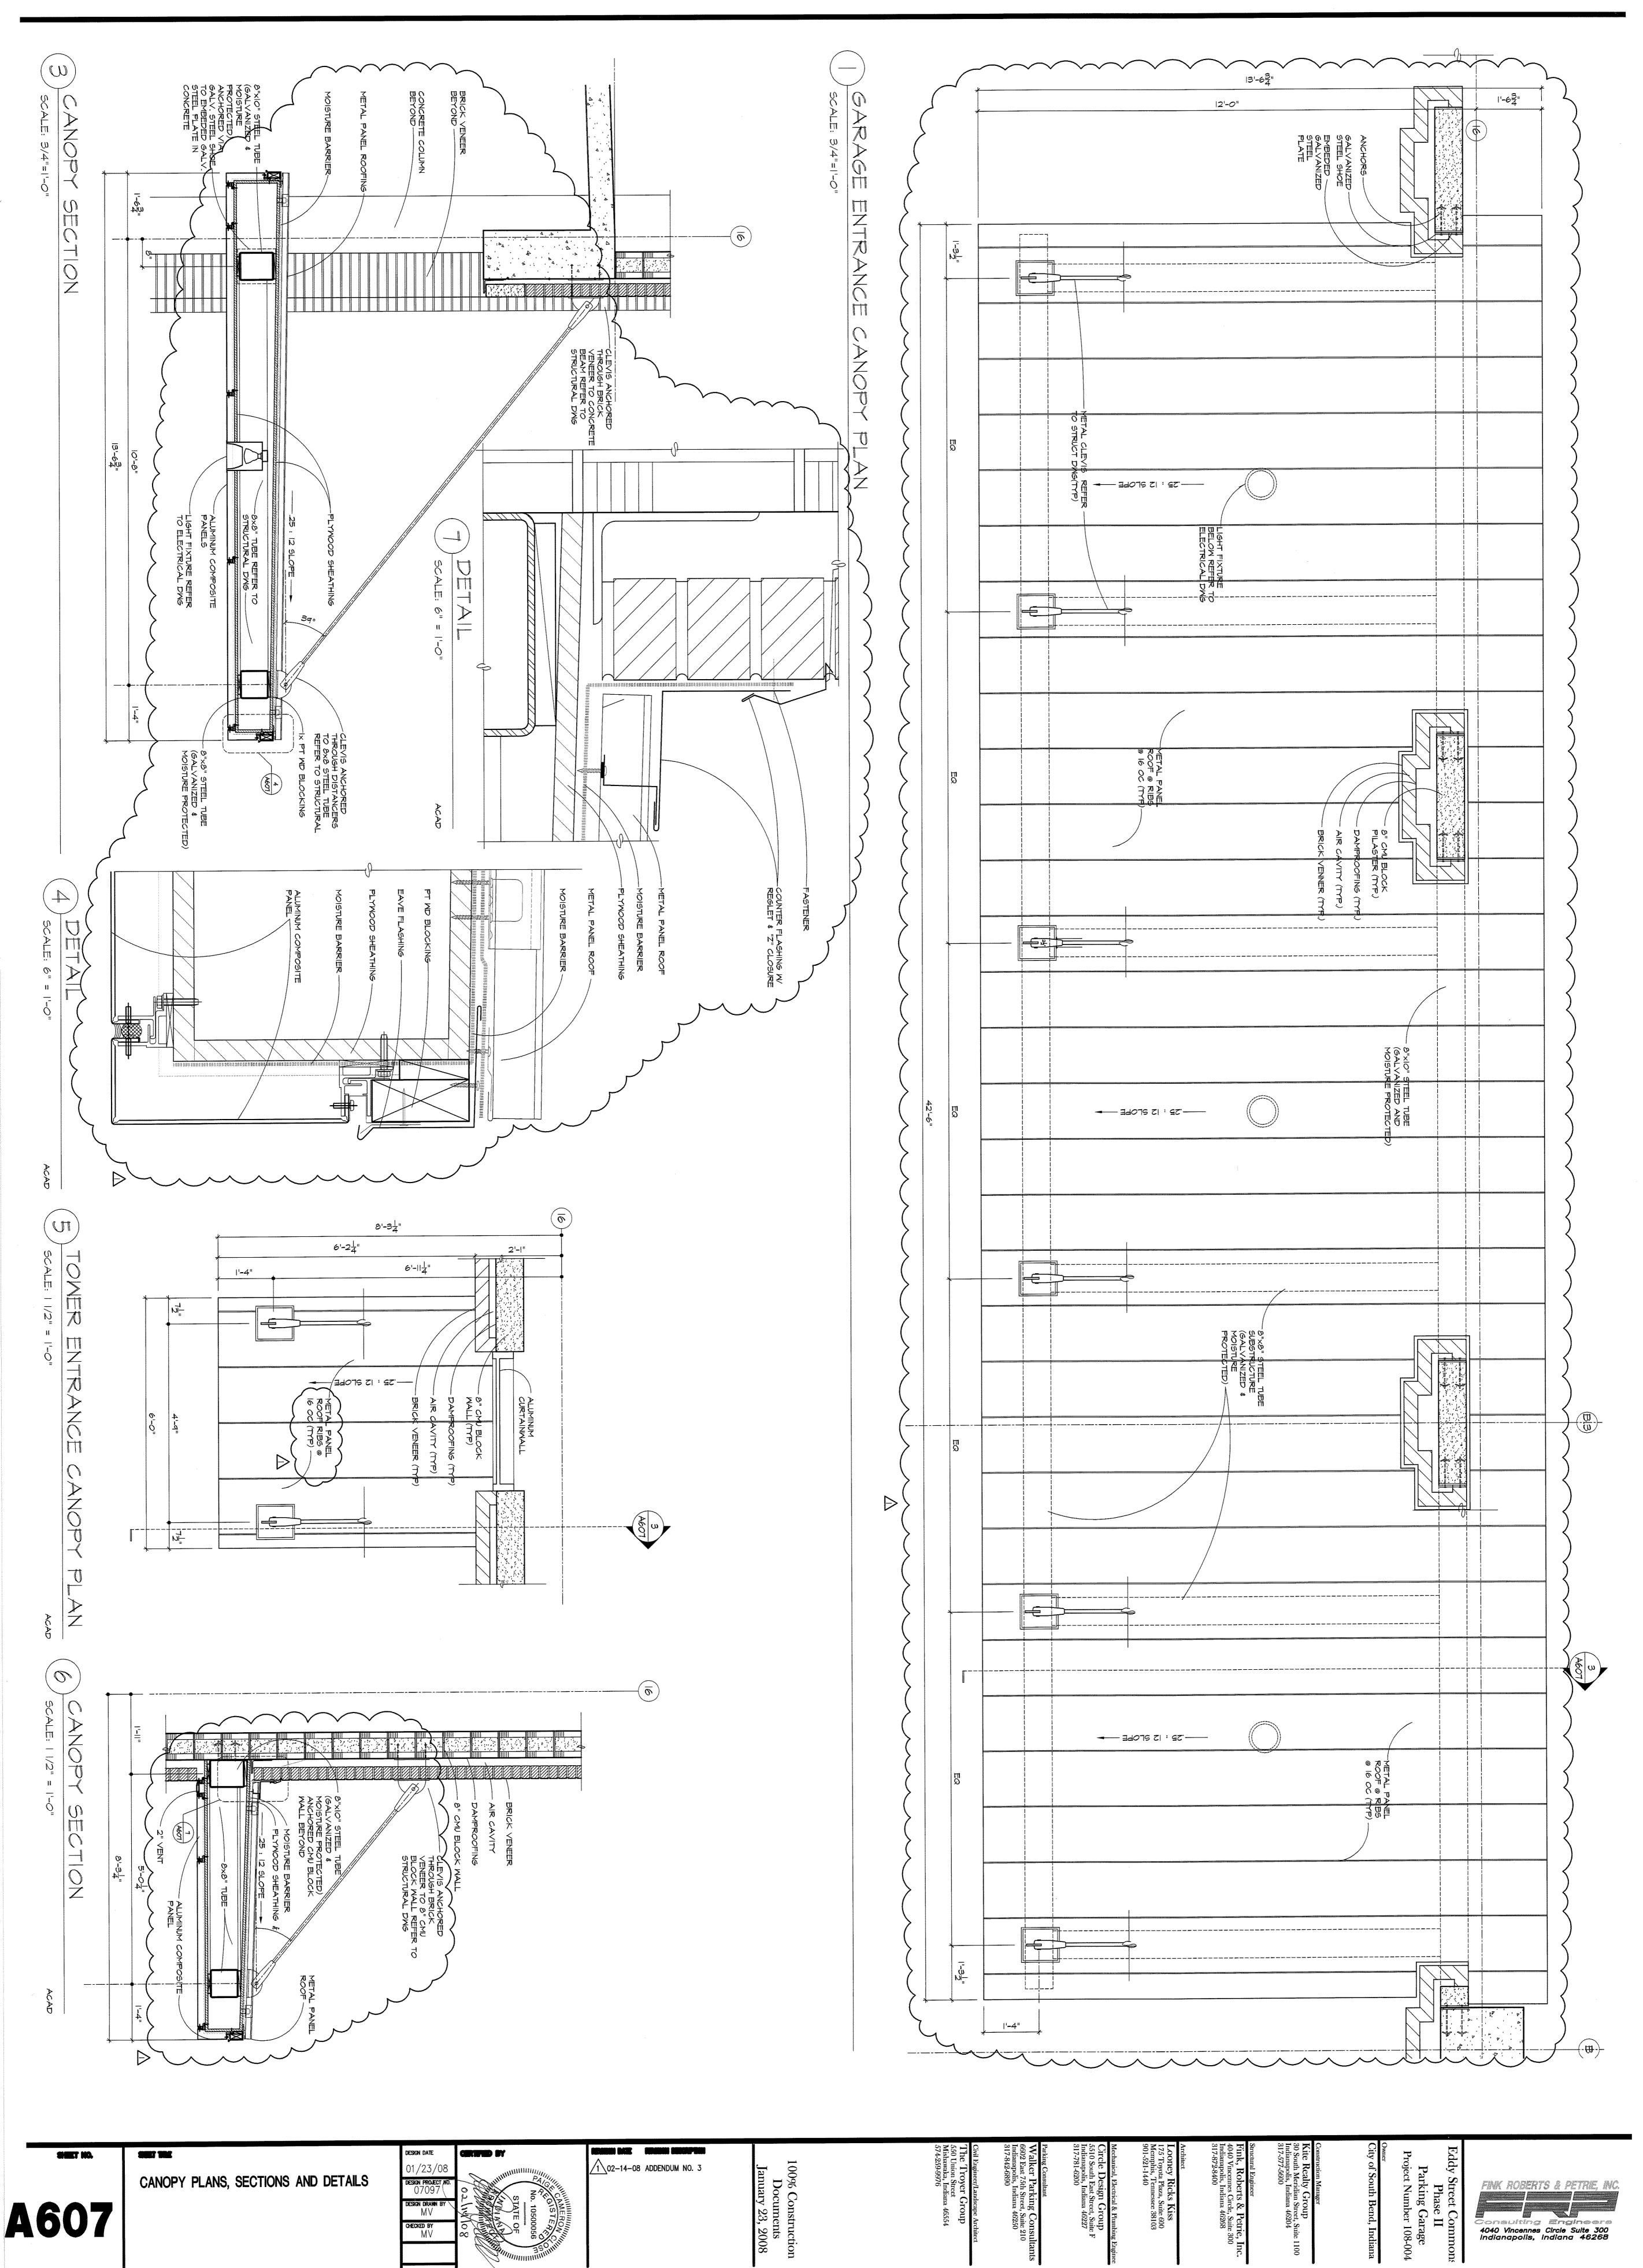


4040 Vincennes Circle Suite 300 Indianapolis, Indiana 46268

8" FIRE SERVICE, 1" WATER SERVICE UP. FOUNDATION PLAN - PLUMBING AND FIRE PROTECTION


SCALE: 1/16" = 1'-0"






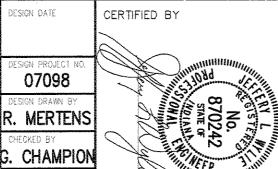





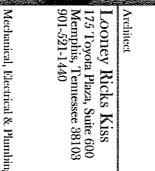



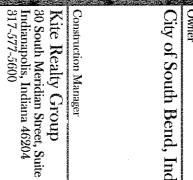

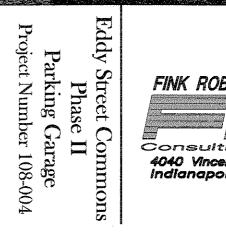

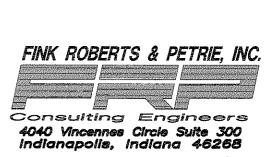

SHEET TITLE

SHEET NO.

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FLOOR PLAN - BASEMENT LEVEL PLUMBING AND FIRE PROTECTION

DESIGN DATE CERTIFIED BY DESIGN PROJECT NO 07098 DESIGN DRAWN BY

R. MERTENS . CHAMPION

REVISION DESCRIPTION REVISION DATE ADDENDUM #1
ADDENDUM #3 02/04/08 02/13/08

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January 23, 2008

Parking Consultant
Walker Parking Consultants
6602 East 75th Street, Suite 210
Indianapolis, Indiana 46250
317-842-6890

Eddy Street Commons
Phase II
Parking Garage
Project Number 108-004 FINK ROBERTS & PETRIE, INC. Consulting Engineers 4040 Vincennes Circle Suite 300 Indianapolis, Indiana 46268

HEAD 165' F 165' F

3. INSTALL SPRINKLER SYSTEM PER NFPA 13
4. COORDINATE SPRINKLER HEAD LAYOUT WITH ALL OTHER CEILING DEVICES.
5. ROUTE ALL SPRINKLER MAINS, BRANCH PIPING AND SPRINKLER HEAD RUN OUT PIPING AS TIGHT TO DECK AS POSSIBLE. COORDINATE ROUTING WITH ALL DUCTWORK AND OTHER TRADES.

TO FABRICATION OF SYSTEM. KLER HEADS AND PIPING L COST TO THE OWNER.

Owner
City of South Bend, Indiana


Kite Realty Group 30 South Meridian Street, Suite 1100 Indianapolis, Indiana 46204 317-577-5600

SHEET TITLE

GROUND LEVEL A. 2 □ A.

SHEET NO. SHEET TITLE E102 ELECTRICAL

@\elect\07098\ Flotted By: Time of Plot:2/13/08-12:10pm Last Edited: 2/13/08-12:05pm

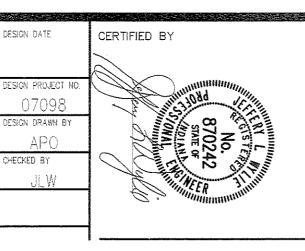

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Documents
January 23, 2008

REVISION DATE REVISION DESCRIPTION
02/14/08 1 ADDENDUM #3

3/4" CONDUIT, 3 #10, 1 #10 GROUND TO PANEL "GL1" IN BASEMENT. REFER TO PARKING DRAWINGS FOR ADDITIONAL WORK. ALSO REFER TO ALTERNATE SECTION IN SPECIFICATIONS.

1" CONDUIT WITH PULL WIRE TO TELEPHONE TERMINAL BOARD IN BASEMENT. REFER TO PARKING DRAWINGS FOR ADDITIONAL WORK. ALSO REFER TO ALTERNATE SECTION IN SPECIFICATIONS.

CONNECT AUTOMATIC PARVINGS.

ONNECT AUTOMATIC PAYMENT MACHINE. CONDUIT AND WIRING TO ANEL "GL1" IN BASEMENT. REFER TO PARKING DRAWINGS FOR DDITIONAL WORK. ALSO REFER TO ALTERNATE SECTION IN PECIFICATIONS.

Structural Engineer

Fink, Roberts & Petrie, Inc.

4040 Vincennes Circle, Suite 300
Indianapolis, Indiana 46268
317-872-8400

IED ARCHITECTURAL HEAVY-DUTY NTEGRAL THERMOSTAT AND) Q-MARK #AWH-4407/

LOCATE FIXTURE(S) ON DOWN RAMP TO BASEMENT LEVEL
AND FEED FROM CIRCUIT IN BASEMENT.

RECEPTACLE FOR DRY PIPE AIR COMPRESSORS.

FIRE ALARM DEVICE FOR ELEVATOR RECALL.

(5KW-277V-1ø) WALL MOUNTED ELECTRIC PROPELLER UNIT HEATER WITH INTEGRAL THERMOSTAT, DISCONNECT SWITCH AND UNIVERSAL MOUNTING BRACKET. SIMILAR TO Q-MARK #MUH05-71/MT-1 /MPDS-25/MMB-10. FEED FROM PANEL "GH1". SEE SHEET E101.

AZ ZOTES:

Eddy Street Commons
Phase II
Parking Garage
Project Number 108-004


ALL LIGHTING FED FROM PANEL "GH1" VIA INTERIOR LIGHTING CONTACTOR "ILCG1" UNLESS NOTED OTHERWISE. SEE SHEET E101.

ALL RECEPTACLES FED FROM PANEL "GL1". SEE SHEET E101.

ALL NIGHT LIGHTS AND EXITS FED FROM PANEL "GH1" UNLESS NOTED OTHERWISE. SEE SHEET E101.

UTE ALL EXPOSED CONDUITS THROUGH OPENINGS PROVIDED STRUCTURE. DO NOT ROUTE ANYTHING BELOW STRUCTURAL AMS.

FINK ROBERTS & PETRIE, INC. Consulting Engineers 4040 Vincennes Circle Suite 300 Indianapolis, Indiana 46268

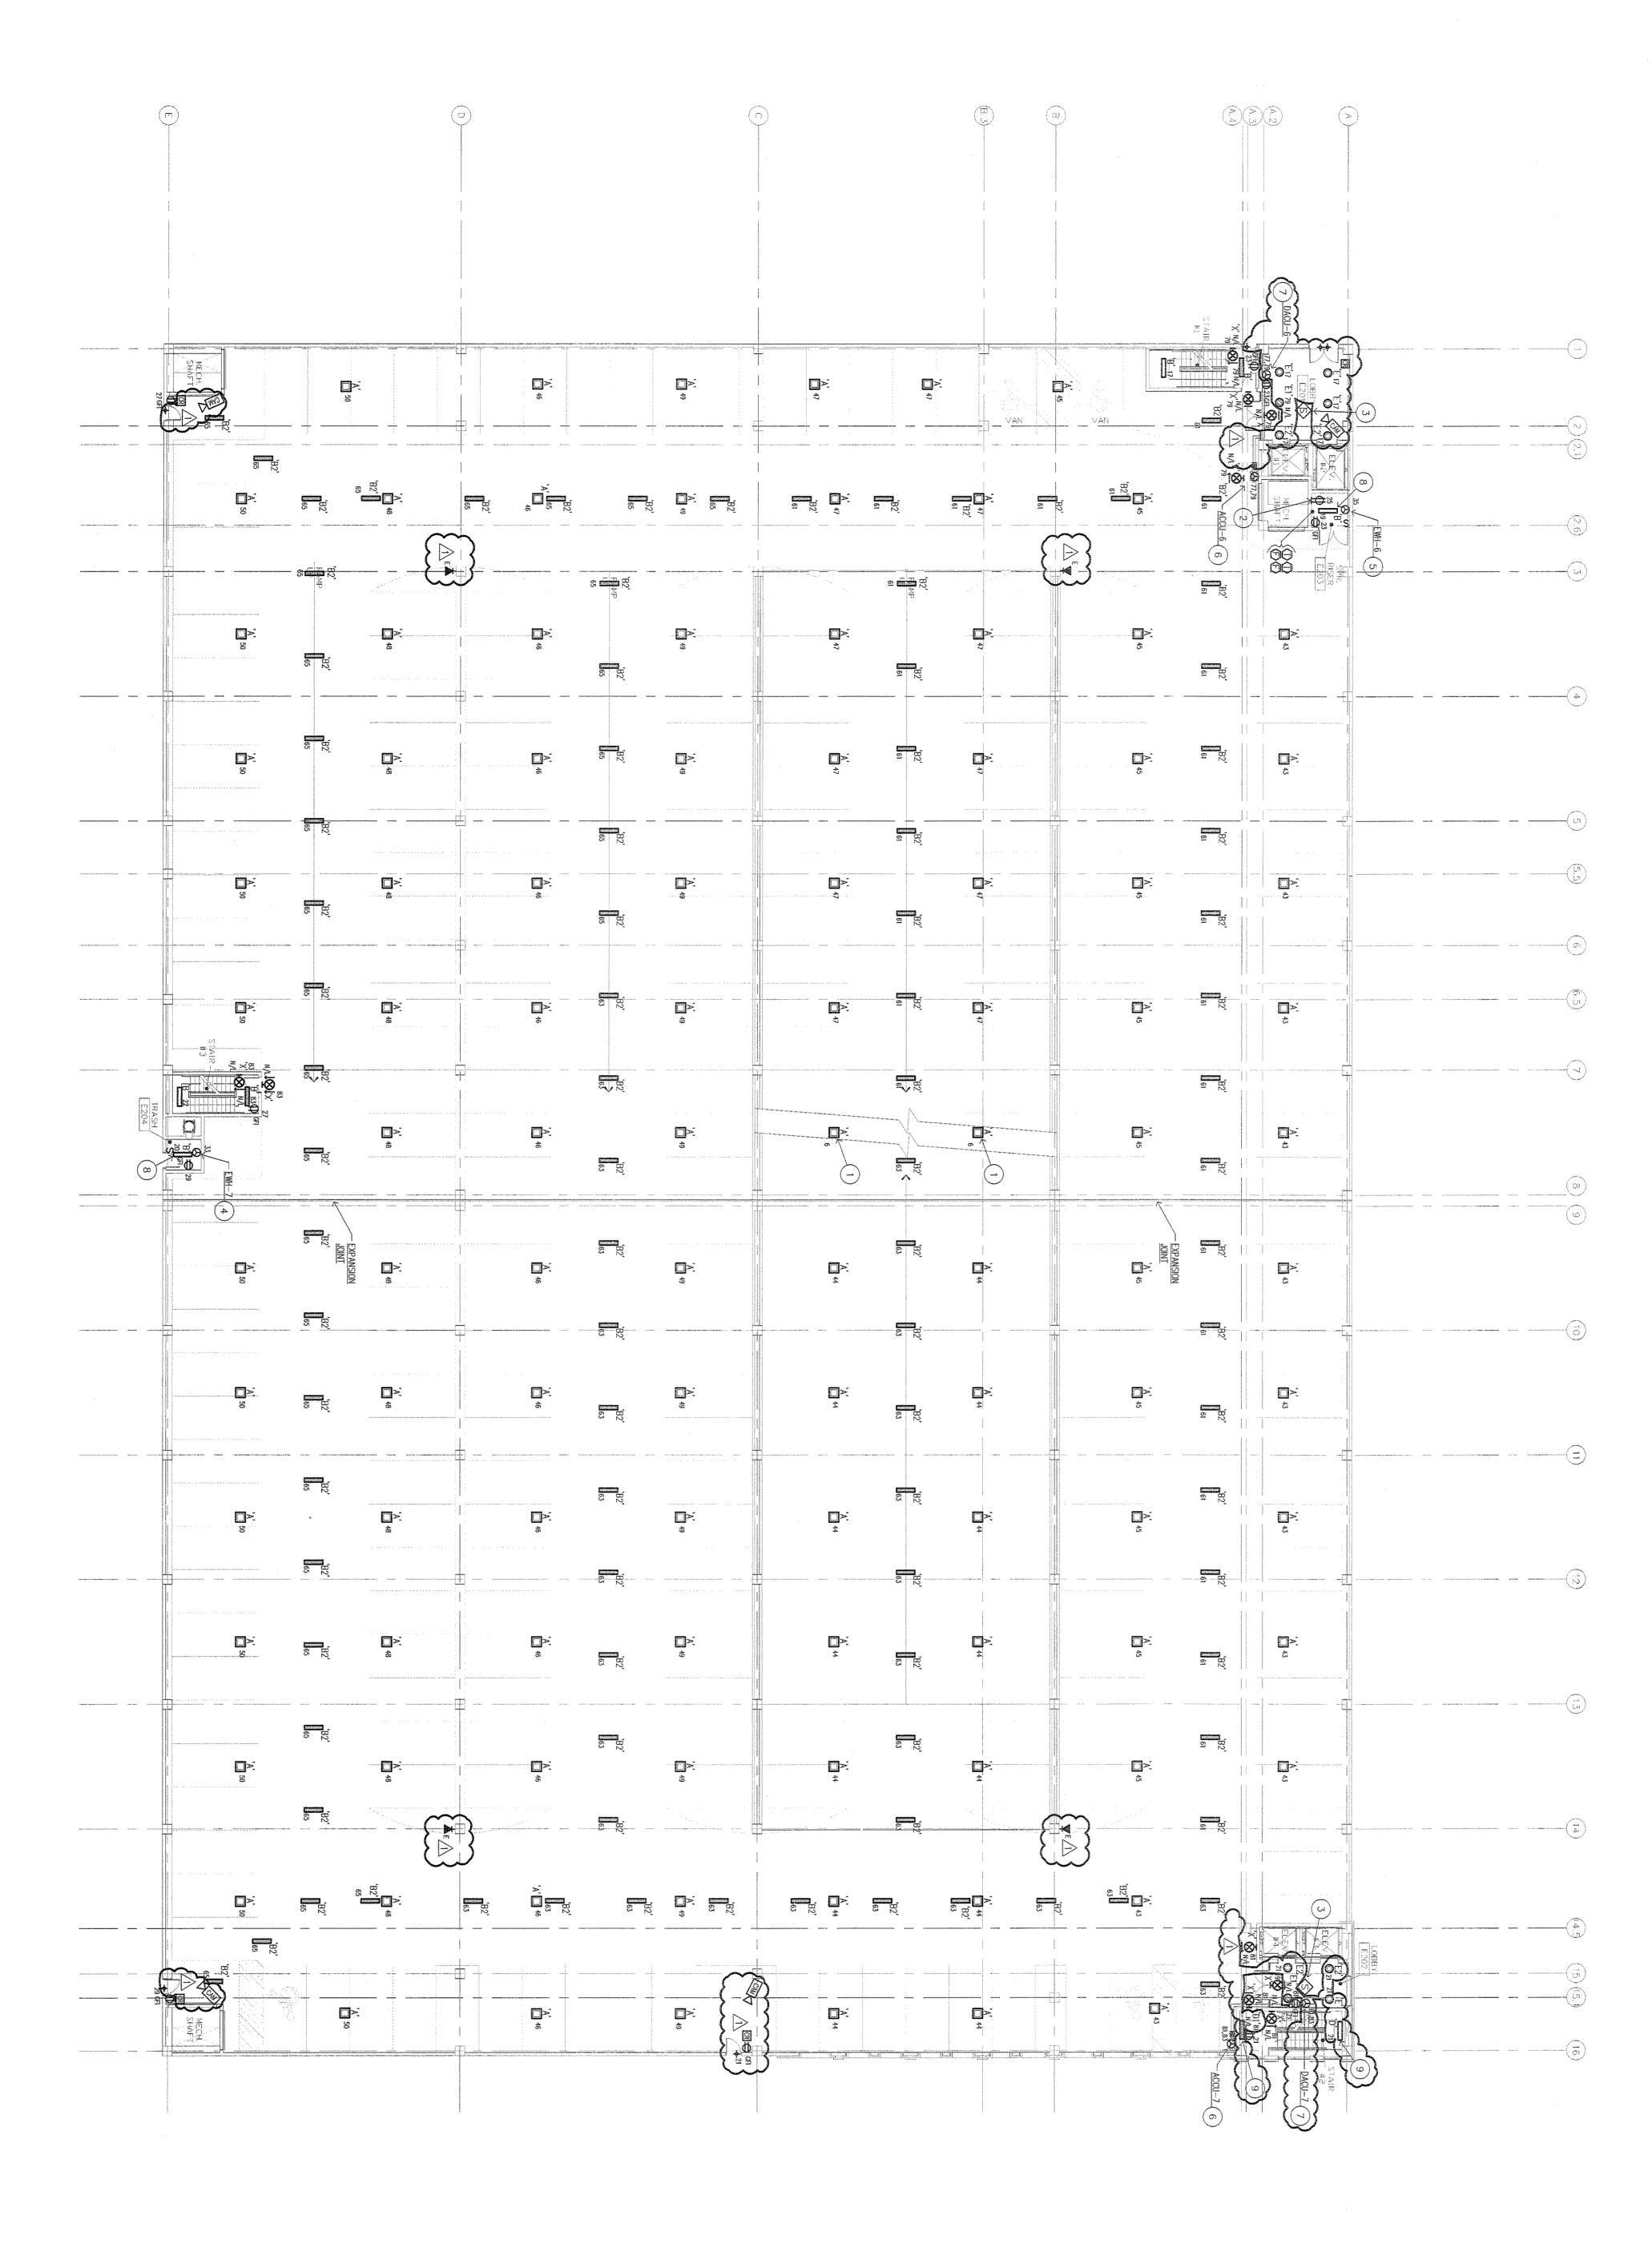

(1.5KW-277V-10) SURFACE MOUNTED ARCHITECTURAL HEAVY-DUTY WALL HEATER WITH CONCEALED INTEGRAL THERMOSTAT AND DISCONNECT SWITCH. SIMILAR TO Q-MARK #AWH-4307/AWH-SM. FEED FROM PANEL "GH1". SEE SHEET E101.


D ARCHITECTURAL HEAVY-I TEGRAL THERMOSTAT AND Q-MARK #AWH-4407/ 1"

LOCATE FIXTURE(S) ON DOWN RAMP FEED FROM CIRCUIT ON GROUND LEV RECEPTACLE FOR DRY PIPE AIR COMFIRE ALARM DEVICE FOR ELEVATOR R

AN NOTES:

SHEET TITLE

SHEET NO.

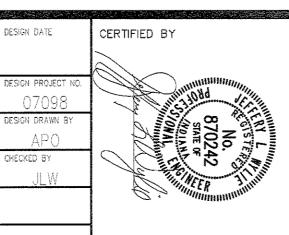


REVISION DATE REVISION DESCRIPTION
02/14/08 1 ADDENDUM #3

Walker Parking Consultants
6602 East 75th Street, Suite 210
Indianapolis, Indiana 46250
317-842-6890

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January 23, 2008

E103

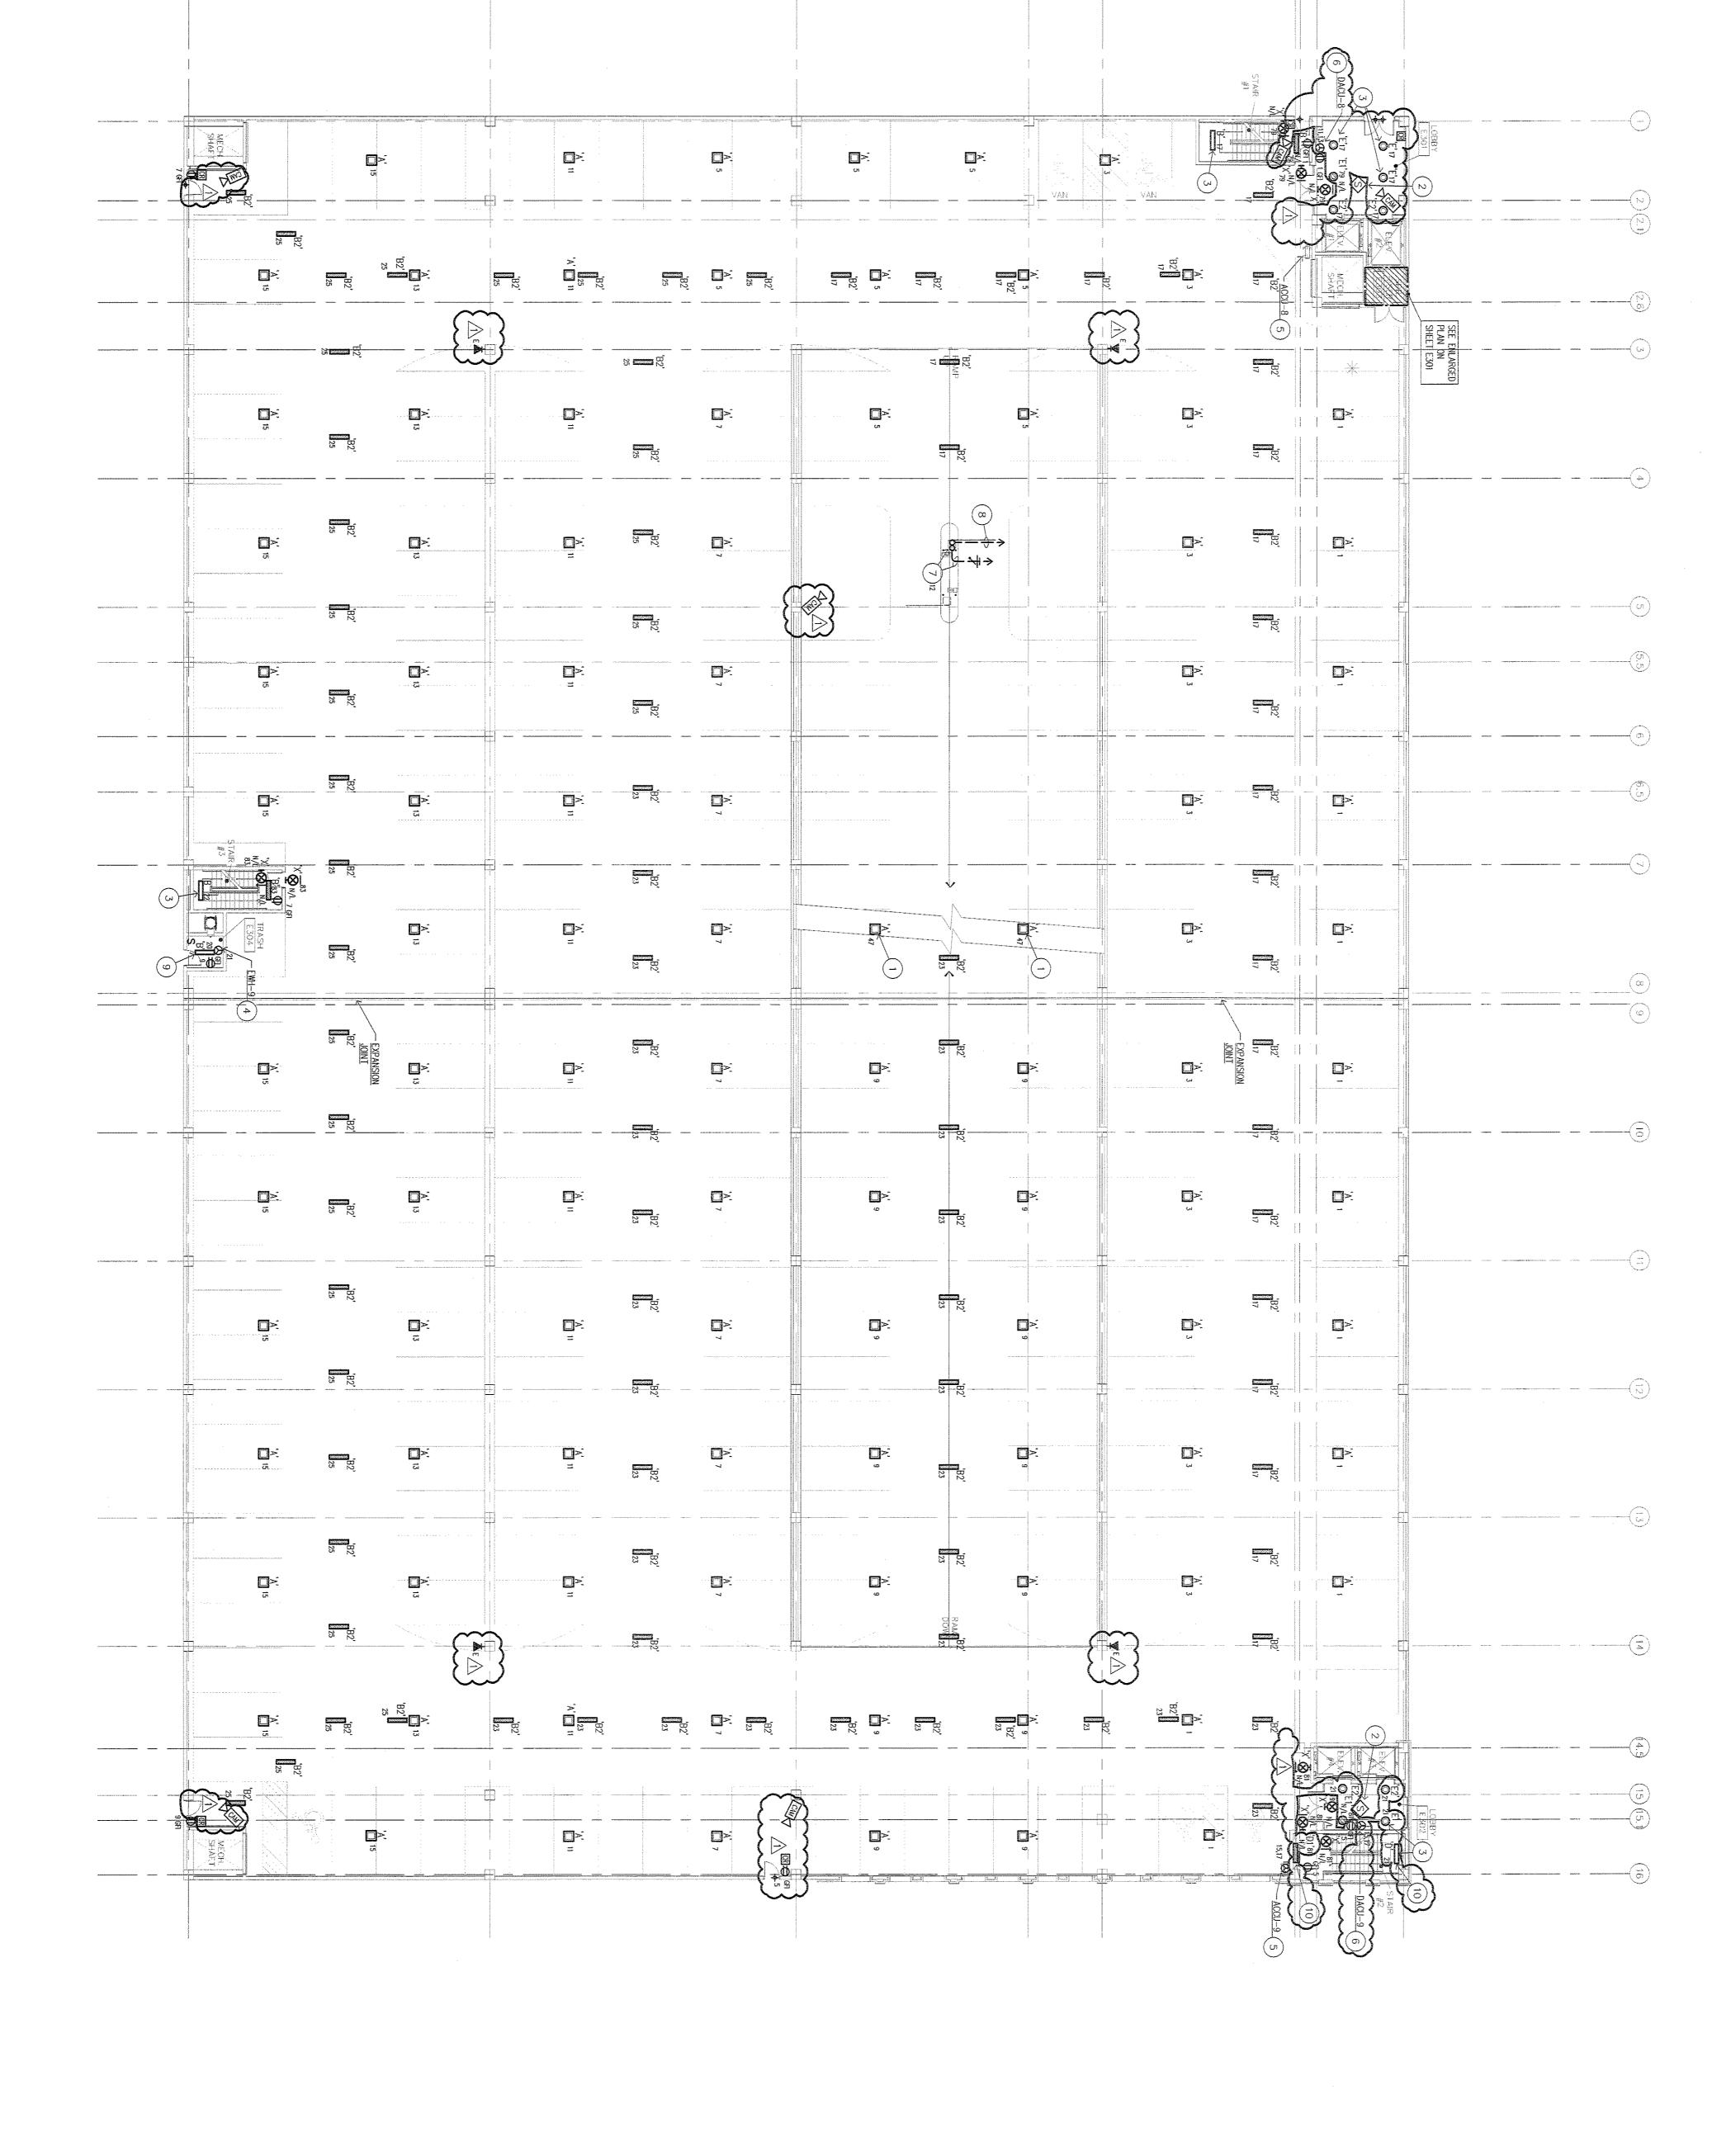


LIGHTING FED FROM PANEL "GH1" VIA INTERIOR LIGHTING CONTACTOR "ILCG1". SEE SHEET E101.

(1.5KW-277V-1ø) SURFACE MOUNTED ARCHITECTURAL HEAVY-DUTY WALL HEATER WITH CONCEALED INTEGRAL THERMOSTAT AND DISCONNECT SWITCH. SIMILAR TO Q-MARK #AWH-4307/AWH-SM. FEED FROM PANEL "GH2". LOCATE FIXTURES ON DOWN RAMP TO SECOND LEVEL.
FIRE ALARM DEVICE FOR ELEVATOR RECALL. 1. MOUNT BOTTOM OF ALL TYPE 'A' LIGHT FIXTURES EVEN WITH BOTTOM OF STRUCTURAL BEAMS.

2. ALL WEATHERPROOF GFI RECEPTACLES TO HAVE LOCABLE INUSE COVERS.

SHEET NO. SHEET TITLE FLOOR PLAN -THIRD LEVEL -ELECTRICAL

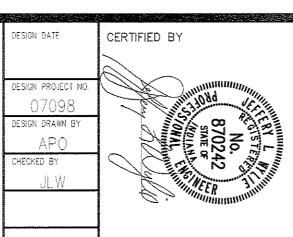

REVISION DATE REVISION DESCRIPTION 02/14/08 1 ADDENDUM #3

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January 23, 2008

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6602 East 75th Street, Suite 210
Indianapolis, Indiana 46250
817-842-6890

CONNECT UNIT AND FEED FROM PANEL "GL2" VIA DISCONNECT SWITCH. UNIT ALSO FEEDS INDOOR UNIT.


UNIT FED FROM OUTDOOR UNIT VIA DISCONNECT SWITCH.

CONNECT AUTO GATES. 3/4" CONDUIT, 2 #10, 1 #10 GROUND TO PANEL "GL2". REFER TO PARKING DRAWINGS FOR ADDITIONAL WORK. ALSO REFER TO ALTERNATE SECTION IN SPECIFICATIONS.

Owner City of South Bend, Indiana

ROUTE ALL EXPOSED CONDUITS THROUGH OPENINGS PROVIDED IN STRUCTURE. DO NOT ROUTE ANYTHING BELOW STRUCTURAL BEAMS. Eddy Street Commons
Phase II
Parking Garage
Project Number 108-004


FINK ROBERTS & PETRIE, INC. Consulting Engineers 4040 Vincennes Circle Suite 300 indianapolis, Indiana 46268

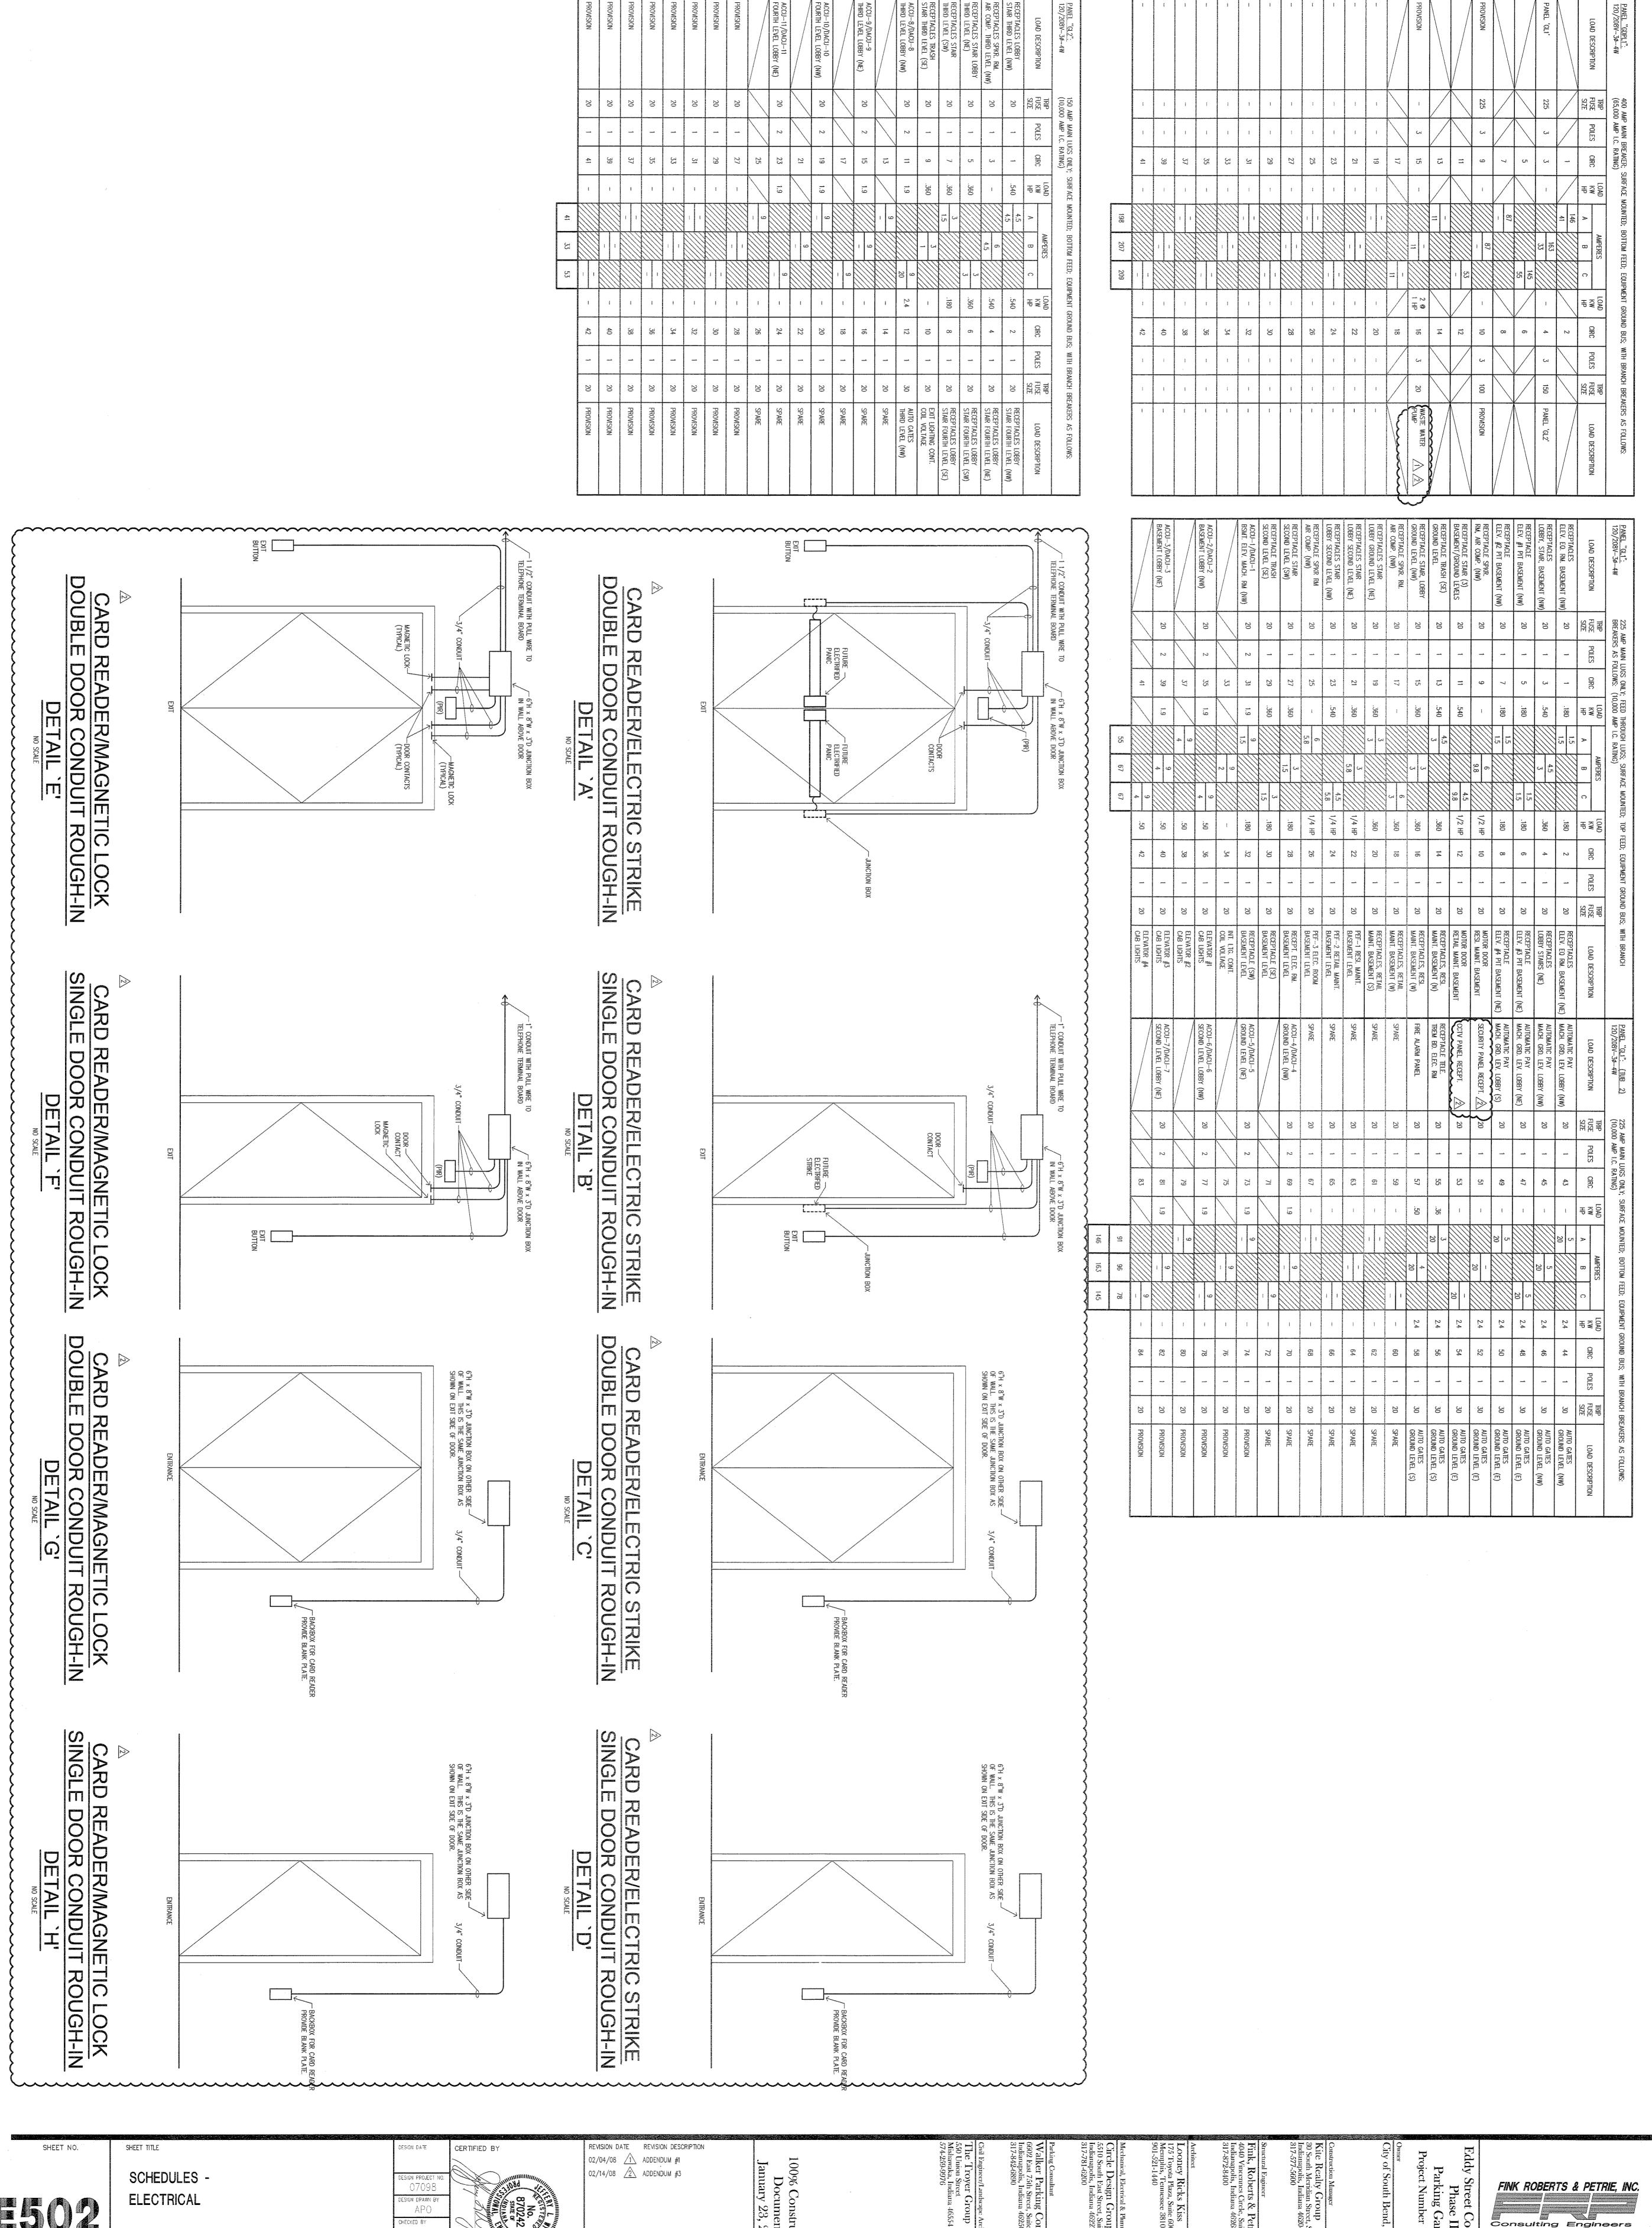

E502

ELECTRICAL


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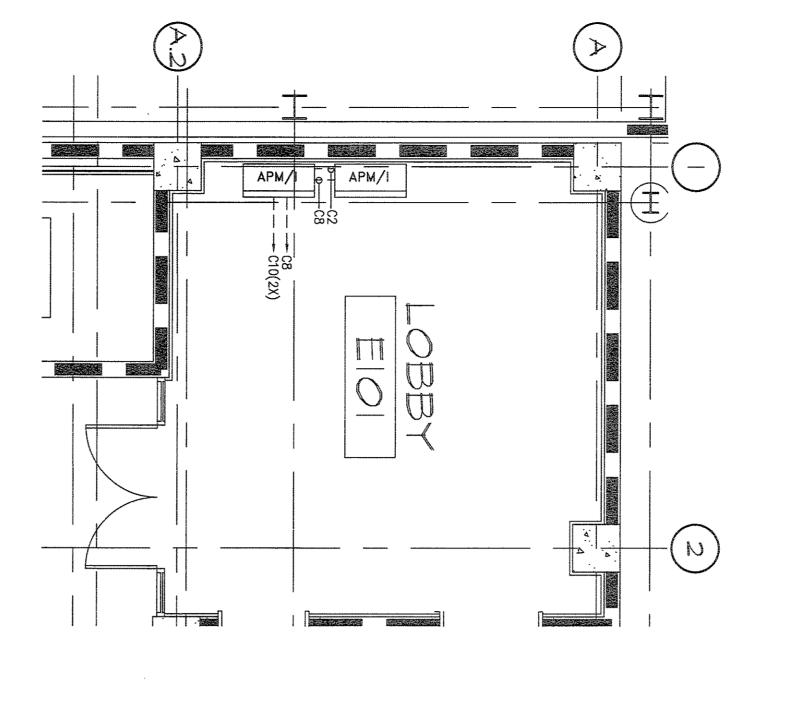


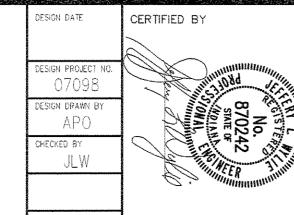
100% Construction
Documents
January 23, 2008


Eddy Street Commons
Phase II
Parking Garage
Project Number 108-004 City of South Bend, Indiana Commons , II

Consulting Engineers 4040 Vincennes Circle Suite 300 Indianapolis, Indiana 46268



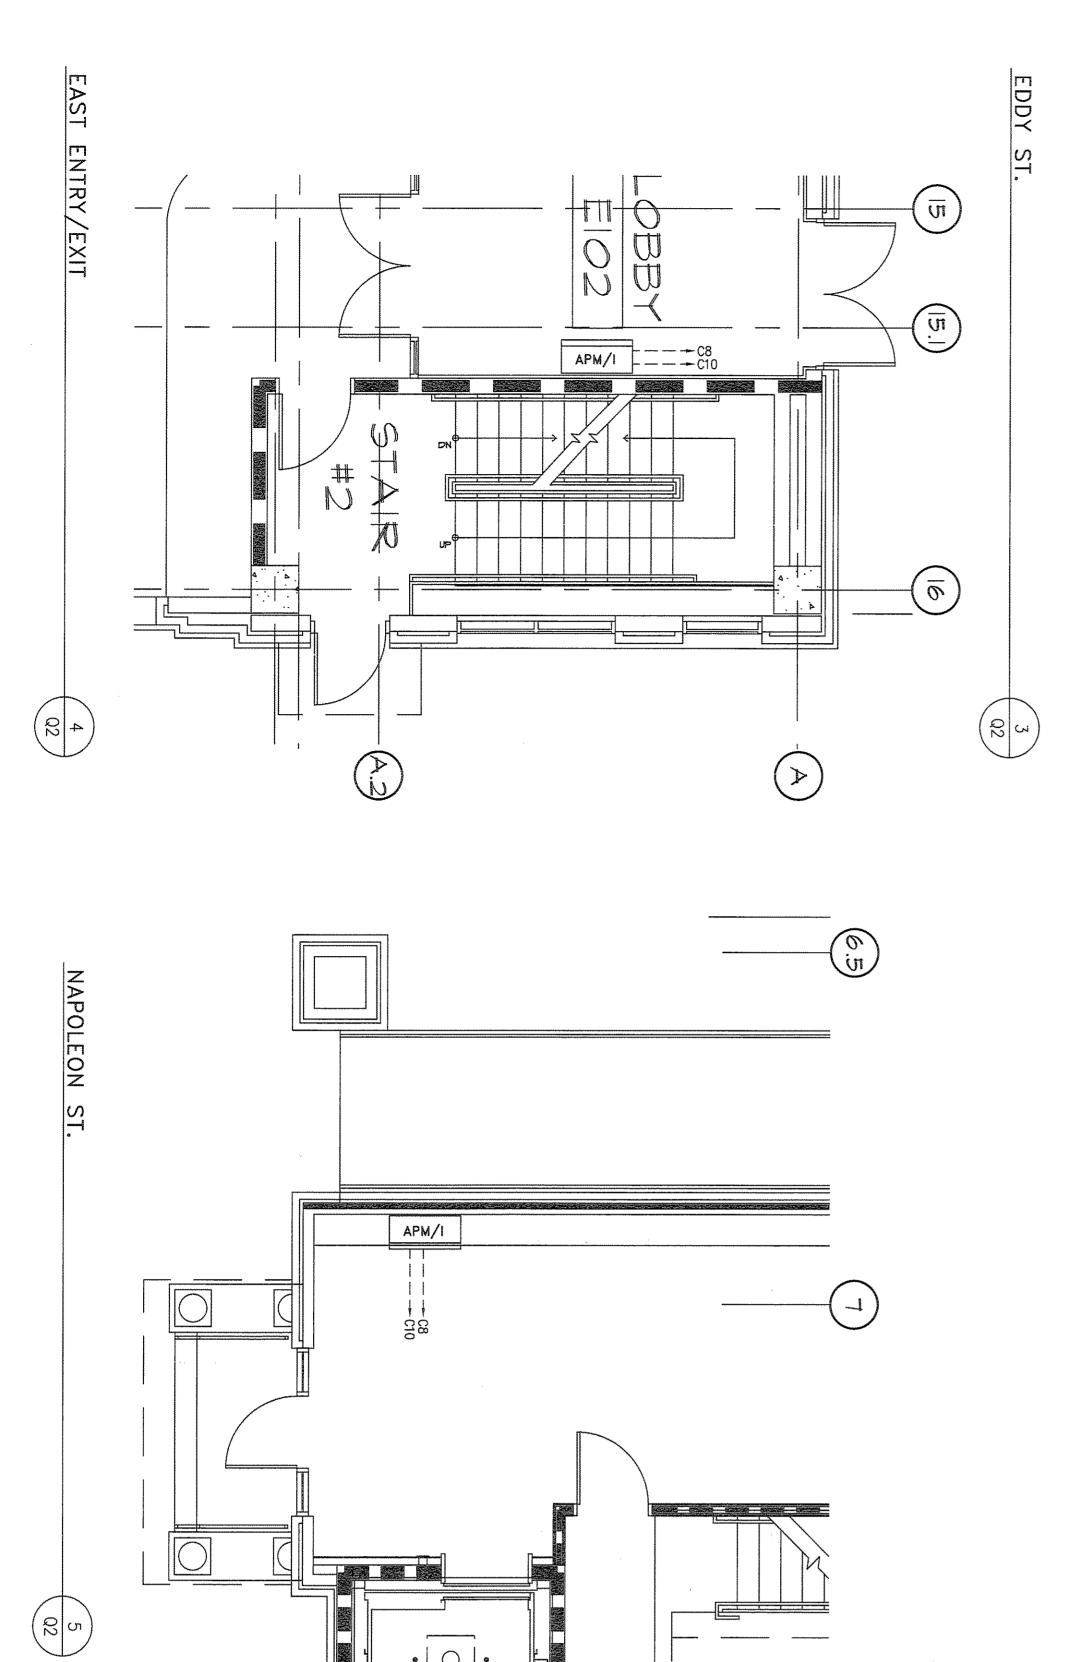

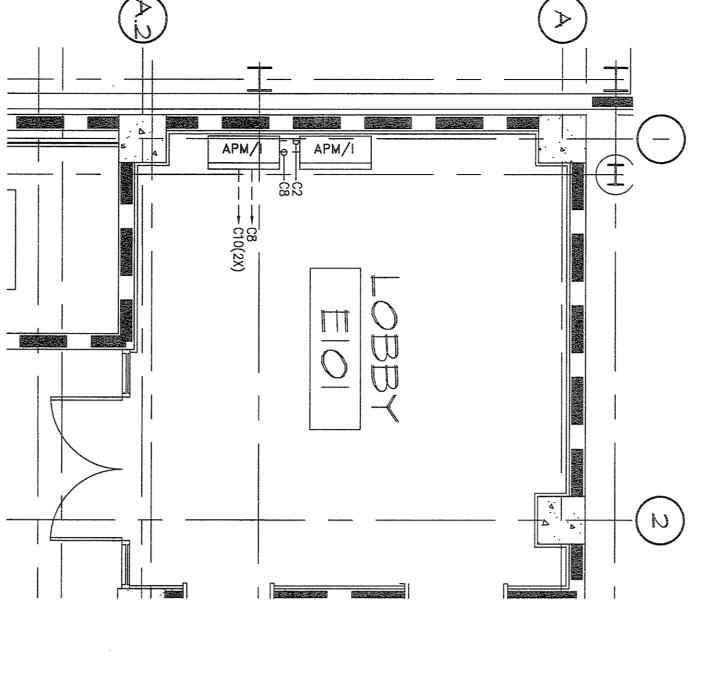

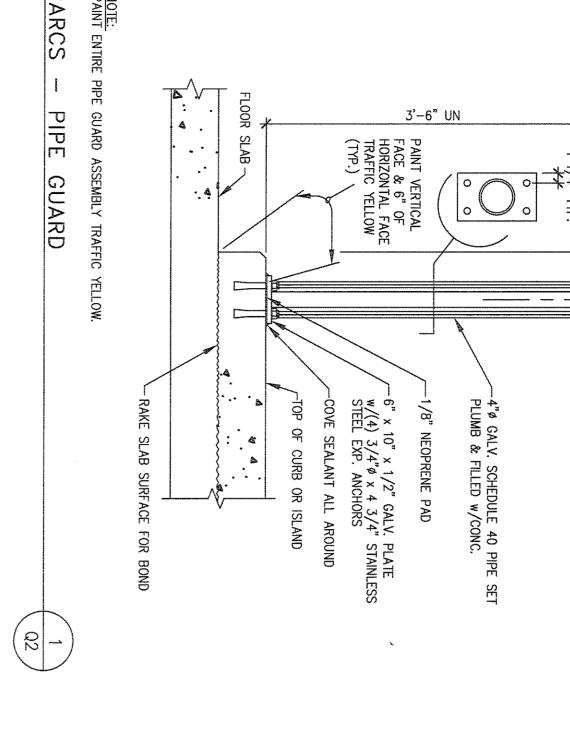

VEHICLE A. VERIFY SIZE OF LOOP, SIZE OF WIRE & NUMBER OF TURN AND NUMBER OF TWSTS PER FOOT IN LOOP LEADS WITH DETECTOR SUPPLIER BEFORE INSTALLATION.

B. LOOP LEAD RUNS SHALL HAVE TWISTS PER FOOT AND ARE LIMITED TO 100 FEET.

C. LOOP AND LOOPS LEADS SHALL BE LOCATED AT LEAST 18" FROM ANY ELECTRICAL POWER SERVICE OR RUNS, AND STEEL REINFORCING IF POSSIBLE.

D. LOOP LEADS SHALL BE IN SEPARATED RIGID CONDUIT BETWEEN LOOP AND DETECTOR. IT MUST NOT SHARE CONDUIT WITH OTHER WIRING OR LEADS FROM OTHER LOOPS.

E. LOOP AND LOOP LEAD WIRE SHALL BE #4 THIN SINGLE CONDUCTOR STRANDED WIRE ALL WIRE TO BE CONTINUOUS WITHOUT SPLICE.

F. PS—E EXIT LANE LOOPS TO BE 12'-0" LONG. DETECTOR/LOOPS

- 3/4" RIGID STEEL CONDUIT w/ (2)#14 THHN TWISTED CONDUCTORS TO VEHICLE DETECTOR UNIT.

— SAWCUT PAVEMENT 1/4" WIDE BY 1 1/2" DEEP FOR SLAB ON GRADE (1" DEEP FOR SUPPORTED FLOOR). INSTALL 4 TURNS OF #14 THHN & FILL SLOT w/3M #202 SEALANT, PRECO INDUST. LTD. "GOLD LABEL FLEX" OR APPROVED EQUIVALENT.

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ENC - ENTRANCE CONTROLLER	AG — AUTO GATE	- CARD READER	BEST STATUTE BUTCHES B	NOTE: HOTEL FRONT DESK WORK	HOTEL FRONT DESK	ELECTRICAL/COMMUNI	PARKING MANAGEMEN	NAPOLEON STREET	EAST ENTRY/EXIT	EDDY STREET	PAYSTATION LOCATION	EXIT LANE	EN RY LANE

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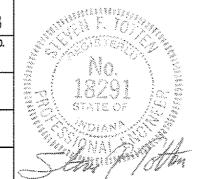
		20 AMP, 120 VOLT CIRCUIT	DATA TO GATE OR APM TO FMS. FROM FMS TO GATE.	TO INTERCOM MASTER PANEL OR EQUIPMENT TO EQUIPMENT. NOT USED.	RIGID STEEL (UNDERGROUND CAN BE PVC). RIGID STEEL LOOP LEAD.	POWER CONDUIT FROM EQUIPMENT TO GATE. NOT USED.	30 AMP, 120 VOLT CIRCUIT, ACTUAL LOAD IS ~ 2400 WATTS.	CONDUIT LEGEND DEFINITION
6. ALL CONDUIT AND WIRING THAT EXTENDS ACROSS AN EXPANSION JOINT SHALL INCLUDE ADEQUATE EXPANSION CAPABILITIES IN THE CONDUIT AND SLACK IN THE POWER AND COMMUNICATIONS CABLING TO ALLOW FREE MOVEMENT. ALLOW FOR ONE (1) INCH OF HORIZONTAL MOVEMENT.	5. ONLY WIRING OF SAME DESIGNATION CAN BE COMBINED IN A SINGLE CONDUIT. INCREASE CONDUIT DIAMETER AS REQUIRED BASED UPON QUANTITY OF CONDUCTORS.	4. COORDINATE WITH ELECTRICAL DRAWINGS FOR POWER SUPPLY AND DATA LINE CONNECTIONS.	3. 100 AMP CONTROL PANEL TO PROVIDE POWER TO ALL ENTRY/EXIT EQUIPMENT. ANTICIPATED ELECTRICAL LOAD IS 24.2 KW.	ALL EMBEDDED AND UNDERGROUND CONDUIT SHALL BE PVC.	ELECTRICAL NOTES: 1. ALL EXPOSED CONDUIT TO BE GALVANIZED.	2. PARCS SUB CONTRACTOR TO INSTALL ALL COMMUNICATIONS WIRING.		GENERAL NOTES: 1. DRAWINGS ARE SCHEMATIC DIAGRAMS. PARCS SLAB CONTRACTOR TO COORDINATE FINAL LOCATION OF

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ENTRANCE CONTROLLER (INTERCOM)

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AUTOMATIC PAY MACHINE (INTERCOM)



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EQUIPMENT INDEX